


## ADDENDUM #1

**Project:** Ogden-Hinkley Airport  
Front Terminal Expansion

**Architect:** Sanders Associates Architects  
2668 Grant Ave. Suite 100  
Ogden, UT 84401

**Owner:** Ogden City

**Project Manager:** Steven Lund AIA  
**Project Number:** 2021-10  
**Date:** 7.10.24

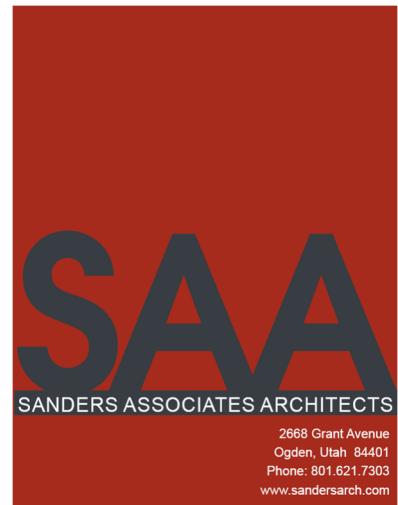

*The following information is intended to amend, alter, expand or clarify the drawings and specifications issued for this project.  
All information in this Addendum shall be made part of the contractor's bid.*

### **BIDDER ITEMS:**

1. Exhibit B: Qualification Information for Interested Bidders Form. Submit by July 17, 4:00 pm. Send by e-mail to: Purchasing@OgdenCity.com.

### **ARCHITECTURAL ITEMS:**

1. **Sheet GI002**
  - a. Airport SIDA Badging Requirements
    - i. The cost for badging testing is \$110 per test.
2. **Sheet C1.1**
  - a. Some of the demolition work at the main entrance and exit areas of the site are shown omitted from the Project to the line of the new design. The existing site is to remain to the line of new design.
3. **Sheet C2.1**
  - a. Some of the site work at the main entrance and exit areas of the site are shown omitted from the Project to the line of the new design. The existing site is to remain to the line of new design.
4. **Sheet C3.1**
  - a. Some of the utility work at the main exit area of the site is omitted from the Project.
5. **Sheet C5.1**
  - a. Some of the erosion control areas at the main entrance and exit of the site are shown omitted from the Project to the line of the new design.

### **LANDSCAPING ITEMS:**

1. **Sheet L1.1**
  - a. Some of the landscape work at the main exit area of the site has been modified.
2. **Sheet L1.2**
  - a. Some of the landscape work at the main entrance area of the site has been modified and areas omitted from the Project.
3. **Sheet L1.3**
  - a. Some of the landscape work at the main exit area of the site has been modified and areas omitted from the Project.
4. **Sheet L2.1**
  - a. Some of the irrigation work at the main exit area of the site has been modified.
5. **Sheet L2.2**
  - a. Some of the irrigation work at the main entrance area of the site has been modified and areas omitted from the Project.
6. **Sheet L2.3**
  - a. Some of the irrigation work at the main exit area of the site has been modified and areas omitted from the Project.

Supporting Documents: Exhibit B, GI002, C0.1, C1.1, C2.1, C3.1, C5.1, L1.1, L1.2, L1.3, L2.1, L2.2, L2.3

**ARCHITECTURAL PRIOR APPROVALS:**


The following Substitution Requests have been reviewed for this Project. Note: All products are to meet Specification Section 016001, "Buy American Preference Requirements (AIP)."

1. SPECIFICATION 074213 "Composite Metal Panel Systems"
  - a. Alfrex LLC: Approved Manufacturer (074213-2.1-B1) (The colors for the metal panels are to be matched and are indicated in 074213-2.4-A-d, 1) DON GREY, Alpolic (wall panels).
2. SPECIFICATION 079100 "Preformed Joint Seals"
  - a. Erie Metal Specialties: Approved Manufacturer (079101-2.1-A1)
3. SPECIFICATION 079513.13 "Interior Expansion Joint Cover Assemblies"
  - a. Erie Metal Specialties: Approved Manufacturer (079513.13-2.3-A) (079513.13-2.4-A)
4. SPECIFICATION 093000 "Tiling"
  - a. Ardex Americas: Approved Manufacturer (093000 2.6 A) (093000 2.7A)

**QUESTIONS:**

1. N/A

End of ADDENDUM #1

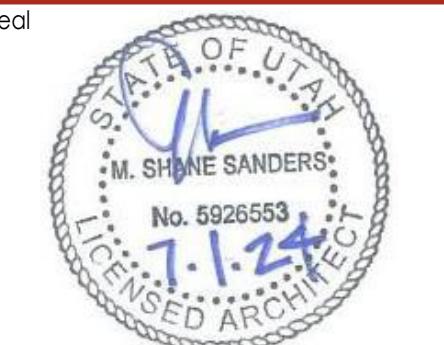

Consultant

## FRONT TERMINAL EXPANSION

3909 AIRPORT ROAD  
OGDEN, UT 84401

Project Name	Issued
1 07.01.24 BID DOCUMENTS	

Revision

1 07.10.24 ADDENDUM 1

M. SHANE SANDERS

7-1-24

LICENSED ARCHITECT

7-1-24

2021-10

SAA Project No.

2021-10

Drawing Title

GENERAL INFORMATION

Sheet Number

G1002

## MISCELLANEOUS GENERAL NOTES

1. THE PROJECT MANUAL, UNDER SEPARATE COVER, IS AN INTEGRAL PART OF THESE CONSTRUCTION DRAWINGS.
2. ALL DRAWINGS ARE RELATIVE TO THE DRAUGHTS AND DIMENSIONED UNLESS OTHERWISE STATED, TO ALL SITUATIONS OCCURRING THAT ARE THE SAME OR SIMILAR TO THOSE SPECIFICALLY NOTED ON THE DRAWINGS.
3. ALL WORK MATERIALS, AND METHODS SHALL BE IN CONFORMANCE WITH THE CODES, ORDINANCES, AND REGULATIONS OF ALL GOVERNMENTAL AGENCIES, INCLUDING, BUT NOT LIMITED TO, THE STATE OF UTAH.
4. CONTRACTORS ARE RESPONSIBLE FOR ALL WORK REGARDLESS OF THE LOCATION OF THE INFORMATION ON THE DOCUMENTS.
5. KEEP SITE CLEAN AND CLEAR OF DEBRIS AND IN ORDERLY CONDITION THAT DOES NOT DETRACT FROM THE SURROUNDING SITE AND REPAIR ANY DAMAGE CAUSED BY THE CONTRACTOR.
6. INSTALL SEALANT AT EXTERIOR SIDE OF ALL JOINTS, SEAMS, CONNECTIONS OR OPENINGS WHICH WOULD ALLOW WATER OR AIR INFILTRATION EXCEPT AS NOTED OTHERWISE. SEALANT COLOR TO MATCH ADJACENT SURFACE. COLOR REQUIRES ARCHITECTS APPROVAL.
7. ALL COMMERCIAL ACCESSIBLE FACILITIES SHALL BE IDENTIFIED WITH APPROVED SIGNAGE.
8. THE CONTRACTOR IS RESPONSIBLE FOR PROVIDING A WEATHER TIGHT BUILDING, DETAILS AND DIMENSIONS TO DRAWINGS NOTWITHSTANDING, ALL DRAWING CONFLICTS WHICH MAY NOT ALLOW A WEATHER-TIGHT CONSTRUCTION SHALL BE PROVIDED BY THE ATTENDING ARCHITECT.
9. DOCUMENTS, WHETHER ACTUAL CONTRACTS AND PLANS SHALL BE BROUGHT TO THE ATTENTION OF THE ARCHITECT. CONTRACTOR SHALL SUBMIT SPECIFIC DISCREPANCIES FOR ARCHITECT REVIEW.
10. PROVIDE FULL METAL BACKING PLATE (16 GAUGE X 96 SECURED TO 3 STUDS MAX) OR WOOD BLOCKING AS REQUIRED TO SECURE THE ANCHOR ALL WALLS, CEILINGS, FLOOR, ROOF, ETC. TO THE EXISTING CONCRETE, METAL HARDWARE, ETC.). BLOCKING SHALL PROVIDE A RIGID CONNECTION CAPABLE OF SUPPORTING DESIGN LOADS. PROVIDE A 16 GAUGE X 8 STL STUD/TRACK SECURED TO 3 STUDS TO SECURELY SUPPORT ALL WALL STOPS (DOOR BUMPERS).
11. CONTRACTOR SHALL COORDINATE WITH ALL TRADES, SIZES AND LOCATIONS OF ALL OPENINGS FOR MECHANICAL, PLUMBING AND ELECTRICAL EQUIPMENT PADS OR BASES, AS WELL AS ELECTRIC POWER, WATER, AND DRAINAGE INSTALLATIONS, BEFORE PROCEEDING WITH WORK. CONTRACTOR SHALL PROVIDE COORDINATION DRAWINGS FOR PROPER PLACEMENT OF ALL TRADES OPENINGS. ANY CONCERNED LIMITATIONS OR STRUCTURAL CONCERN SHALL BE BROUGHT TO THE ATTENTION OF THE ARCHITECT. A REASONABLE RESPONSE TIME SHALL BE ALLOWED AS NOTED IN THE SPECIFICATIONS.
12. ALL FLOOR OR WALL OPENINGS REQUIRED FOR PIPES, DUCTS, CONDUITS, ETC. SHALL BE EASILY ACCESSIBLE AND UNOBSTRUCTED.
13. PRE-PLINKER TOUGH TO BE DONE BY A CERTIFIED SUB-CONTRACTOR PRIOR TO SUBMITAL TO ARCHITECT. SUBMITAL TO THE ARCHITECT ALSO INDICATES THAT THE CONTRACTOR HAS REVIEWED AND COORDINATED FIRE-SPRINKLER PIPING LOCATIONS WITH ALL TRADES.
14. ROOMS PASSING THROUGH WALLS REQUIRE FIRE DAMPERS AND OR FIRE-DOORS. DAMPERS, ANY CONDUIT OR PIPING REQUIRES RATED SEALANT AT JOINTS.
15. IT IS THE CONTRACTOR'S RESPONSIBILITY TO COORDINATE AND LOCATE ELECTRICAL DATA AND PHONE RECEPTACLES, SWITCHES, ETC. TO AVOID CASEWORK DOORS, ETC.
16. THE CONTRACTOR'S DRAWINGS AND SPECIFICATIONS INDICATE THE GENERAL SCOPE OF THE PROJECT IN TERMS OF THE ARCHITECTURAL AND STRUCTURAL DESIGN CONCEPT, THE DIMENSIONS OF THE BUILDING, THE TYPE OF STRUCTURAL, MECHANICAL, ELECTRICAL AND UTILITY SYSTEMS AND MAJOR ARCHITECTURAL ELEMENTS OF CONSTRUCTION AS "SCOPE" DOCUMENTS.

## DRAWING INDEX

### GENERAL INFORMATION

G001	COVER SHEET
G002	GENERAL INFORMATION
G003	CODE SUMMARY PLANS
G004	CODE SUMMARY
G005	ACCESSIBILITY DETAILS FOR NEW & EXISTING CONSTRUCTION
G006	ACCESSIBILITY DETAILS/ RAMP & STAIRS/ SIGNAGE TYPES & DETAILS

### CIVIL

C0.0	COVER SHEET
C0.1	DEVELOPMENT PLAN
C1.1	SITE PLAN
C2.1	GRADING PLAN
C3.1	UTILITY PLAN
C4.1	DETAILS
C4.2	DETAILS
C4.3	DETAILS
C4.4	DETAILS
C5.1	EROSION CONTROL PLAN
C5.2	EROSION CONTROL DETAILS

### LANDSCAPE

L1.1	LANDSCAPE PLAN
L1.2	LANDSCAPE PLAN
L1.3	LANDSCAPE PLAN
L2.1	IRRIGATION PLAN
L2.2	IRRIGATION PLAN
L2.3	IRRIGATION PLAN

### ARCHITECTURAL

A0101	DEMOITION BASEMENT FLOOR PLAN - ADD. ALT. #1
A0103	DEMOLITION MAIN LEVEL FLOOR PLAN AREA B
A0122	DEMOLITION ROOF AREA B
A0141	DEMOLITION BASEMENT REFLECTED CEILING PLAN - ADD. ALT. #1
A0143	DEMOLITION MAIN LEVEL REFLECTED CEILING PLAN AREA B
A1S01	ARCHITECTURAL SITE DETAILS
AE100	INTERIOR ARCHITECTURAL CONCRETE BENCHES
AE101	BUILDING LAYOUT PLAN
AE102	MAIN LEVEL FLOOR PLAN
AE103	BASEMENT FLOOR PLAN - ADD. ALT. #1
AE110	CLERESTORY PLAN
AE121	ROOF PLAN
AE141	MAIN LEVEL REFLECTED CEILING PLAN
AE142	BASEMENT REFLECTED CEILING PLAN - ADD. ALT. #1
AE143	MAIN LEVEL FLOOR PLAN
AE152	BASEMENT FLOOR PLAN - ADD. ALT. #1
AE201	EXTERIOR ELEVATIONS
AE202	EXTERIOR ELEVATIONS
AE203	3D EXTERIOR VIEW
AE301	BUILDING SECTIONS
AE321	WALL SECTIONS
AE322	WALL SECTIONS
AE323	WING WALL SECTIONS & DETAILS
AE421	ENLARGED FLOOR PLANS & INTERIOR ELEVATIONS - ADD. ALT. #1
AE441	INTERIOR ELEVATIONS - BASEMENT - ADD. ALT. #1
AE442	INTERIOR ELEVATIONS
AE443	INTERIOR ELEVATIONS
AE444	INTERIOR ELEVATIONS
AE501	STRUCTURAL DETAILS
AE511	PLAN DETAILS
AE521	EXTERIOR DETAILS
AE531	ROOF DETAILS
AE541	CEILING DETAILS
AE581	OPENING DETAILS
AE601	DOOR SCHEDULE
AE621	FRAME TYPES
AE641	FINISH SCHEDULE & DETAILS
AE661	PARTITION TYPES

### STRUCTURAL

S001	STRUCTURAL GENERAL NOTES
S002	STANDARD DETAILS AND SCHEDULES
S101	FOUNDATION PLAN
S201	LOW ROOF FRAMING PLAN
S202	HIGH ROOF FRAMING PLAN
S501	FOUNDATION DETAILS
S502	CANOPY DETAILS
S503	STEEL CONNECTION DETAILS

### PLUMBING

P-0004	PLUMBING SYMBOL LEGEND, SCHED. AND DETAILS
PD-1004	BASEMENT PLUMBING DEMOLITION PLAN - ADD. ALT. #1
P-100	PLUMBING PLAN (EXISTING TERMINAL) AND DETAILS
P-1004	BASEMENT PLUMBING REMODEL PLAN - ADD. ALT. #1
P-101	PLUMBING PLAN (LOBBY AREA) AND DIAGRAMS
HP-100	HVAC / PLUMBING ROOF PLAN (EXISTING TERMINAL)
HP-101	HVAC / PLUMBING ROOF PLAN (LOBBY AREA)

### Mechanical

M-0003	Mechanical symbol legend, and schedules
M-0004	MECHANICAL SYMBOL LEGEND, SCHED. SCHEDULES AND DETAILS - ADD. ALT. #1
M-0005	BASEMENT HVAC DEMOLITION PLAN - ADD. ALT. #1
M-100	LOBBY HVAC PLAN & DETAILS
M-700	MECHANICAL CONTROLS
M-100A	MECHANICAL CONTROLS AND SPECIFICATIONS - ADD. ALT. #1

### ELECTRICAL

E001	ELECTRICAL SYMBOLS AND NOTES
E002	ELECTRICAL SCHEDULES
E009	ELECTRICAL DIAGRAMS
E104	ELECTRICAL SITE PLAN
E200	BASEMENT SYSTEMS PLAN - ADD. ALT. #1
E201	LEVEL 1 - LIGHTING PLAN - AREA B
E202	LEVEL 1 - LIGHTING PLAN - AREA C
E300	BASEMENT POWER PLAN - ADD. ALT. #1
E301	LEVEL 1 - POWER PLAN - AREA A
E302	LEVEL 1 - POWER PLAN - AREA B
E303	LEVEL 1 - POWER PLAN - AREA C
E310	BASEMENT MECHANICAL PLAN - ADD. ALT. #1
E311	LEVEL 1 - MECHANICAL PLAN - AREA B
E311C	LEVEL 1 - MECHANICAL PLAN - AREA C
E380	ONE-LINE DIAGRAM DEMOLITION
E381	ONE-LINE DIAGRAM
E382	PANEL SCHEDULE
E4008	BASEMENT SYSTEMS PLAN - ADD. ALT. #1
E4018	LEVEL 1 - SYSTEM PLAN - AREA B
E4028	LEVEL 1 - SYSTEM PLAN - AREA C
ED501	BASEMENT DEMOLITION PLAN - ADD. ALT. #1
ED501A	LEVEL 1 - DEMOLITION PLAN - AREA A
ED502A	LEVEL 1 - DEMOLITION PLAN - AREA B
ED502C	LEVEL 1 - DEMOLITION PLAN - AREA C
ED502D	LEVEL 1 - CEILING DEMOLITION RCP PLAN - AREA C
F5008	BASEMENT FIRE ALARM PLAN
F511A	LEVEL 1 - FIRE ALARM PLAN - AREA A
F511B	LEVEL 1 - FIRE ALARM PLAN - AREA B
F511C	LEVEL 1 - FIRE ALARM PLAN - AREA C

### GENERAL INFORMATION

1	07.01.24	BID DOCUMENTS
1	07.10.24	ADDENDUM 1

M. SHANE SANDERS

7-1-24

LICENSED ARCHITECT


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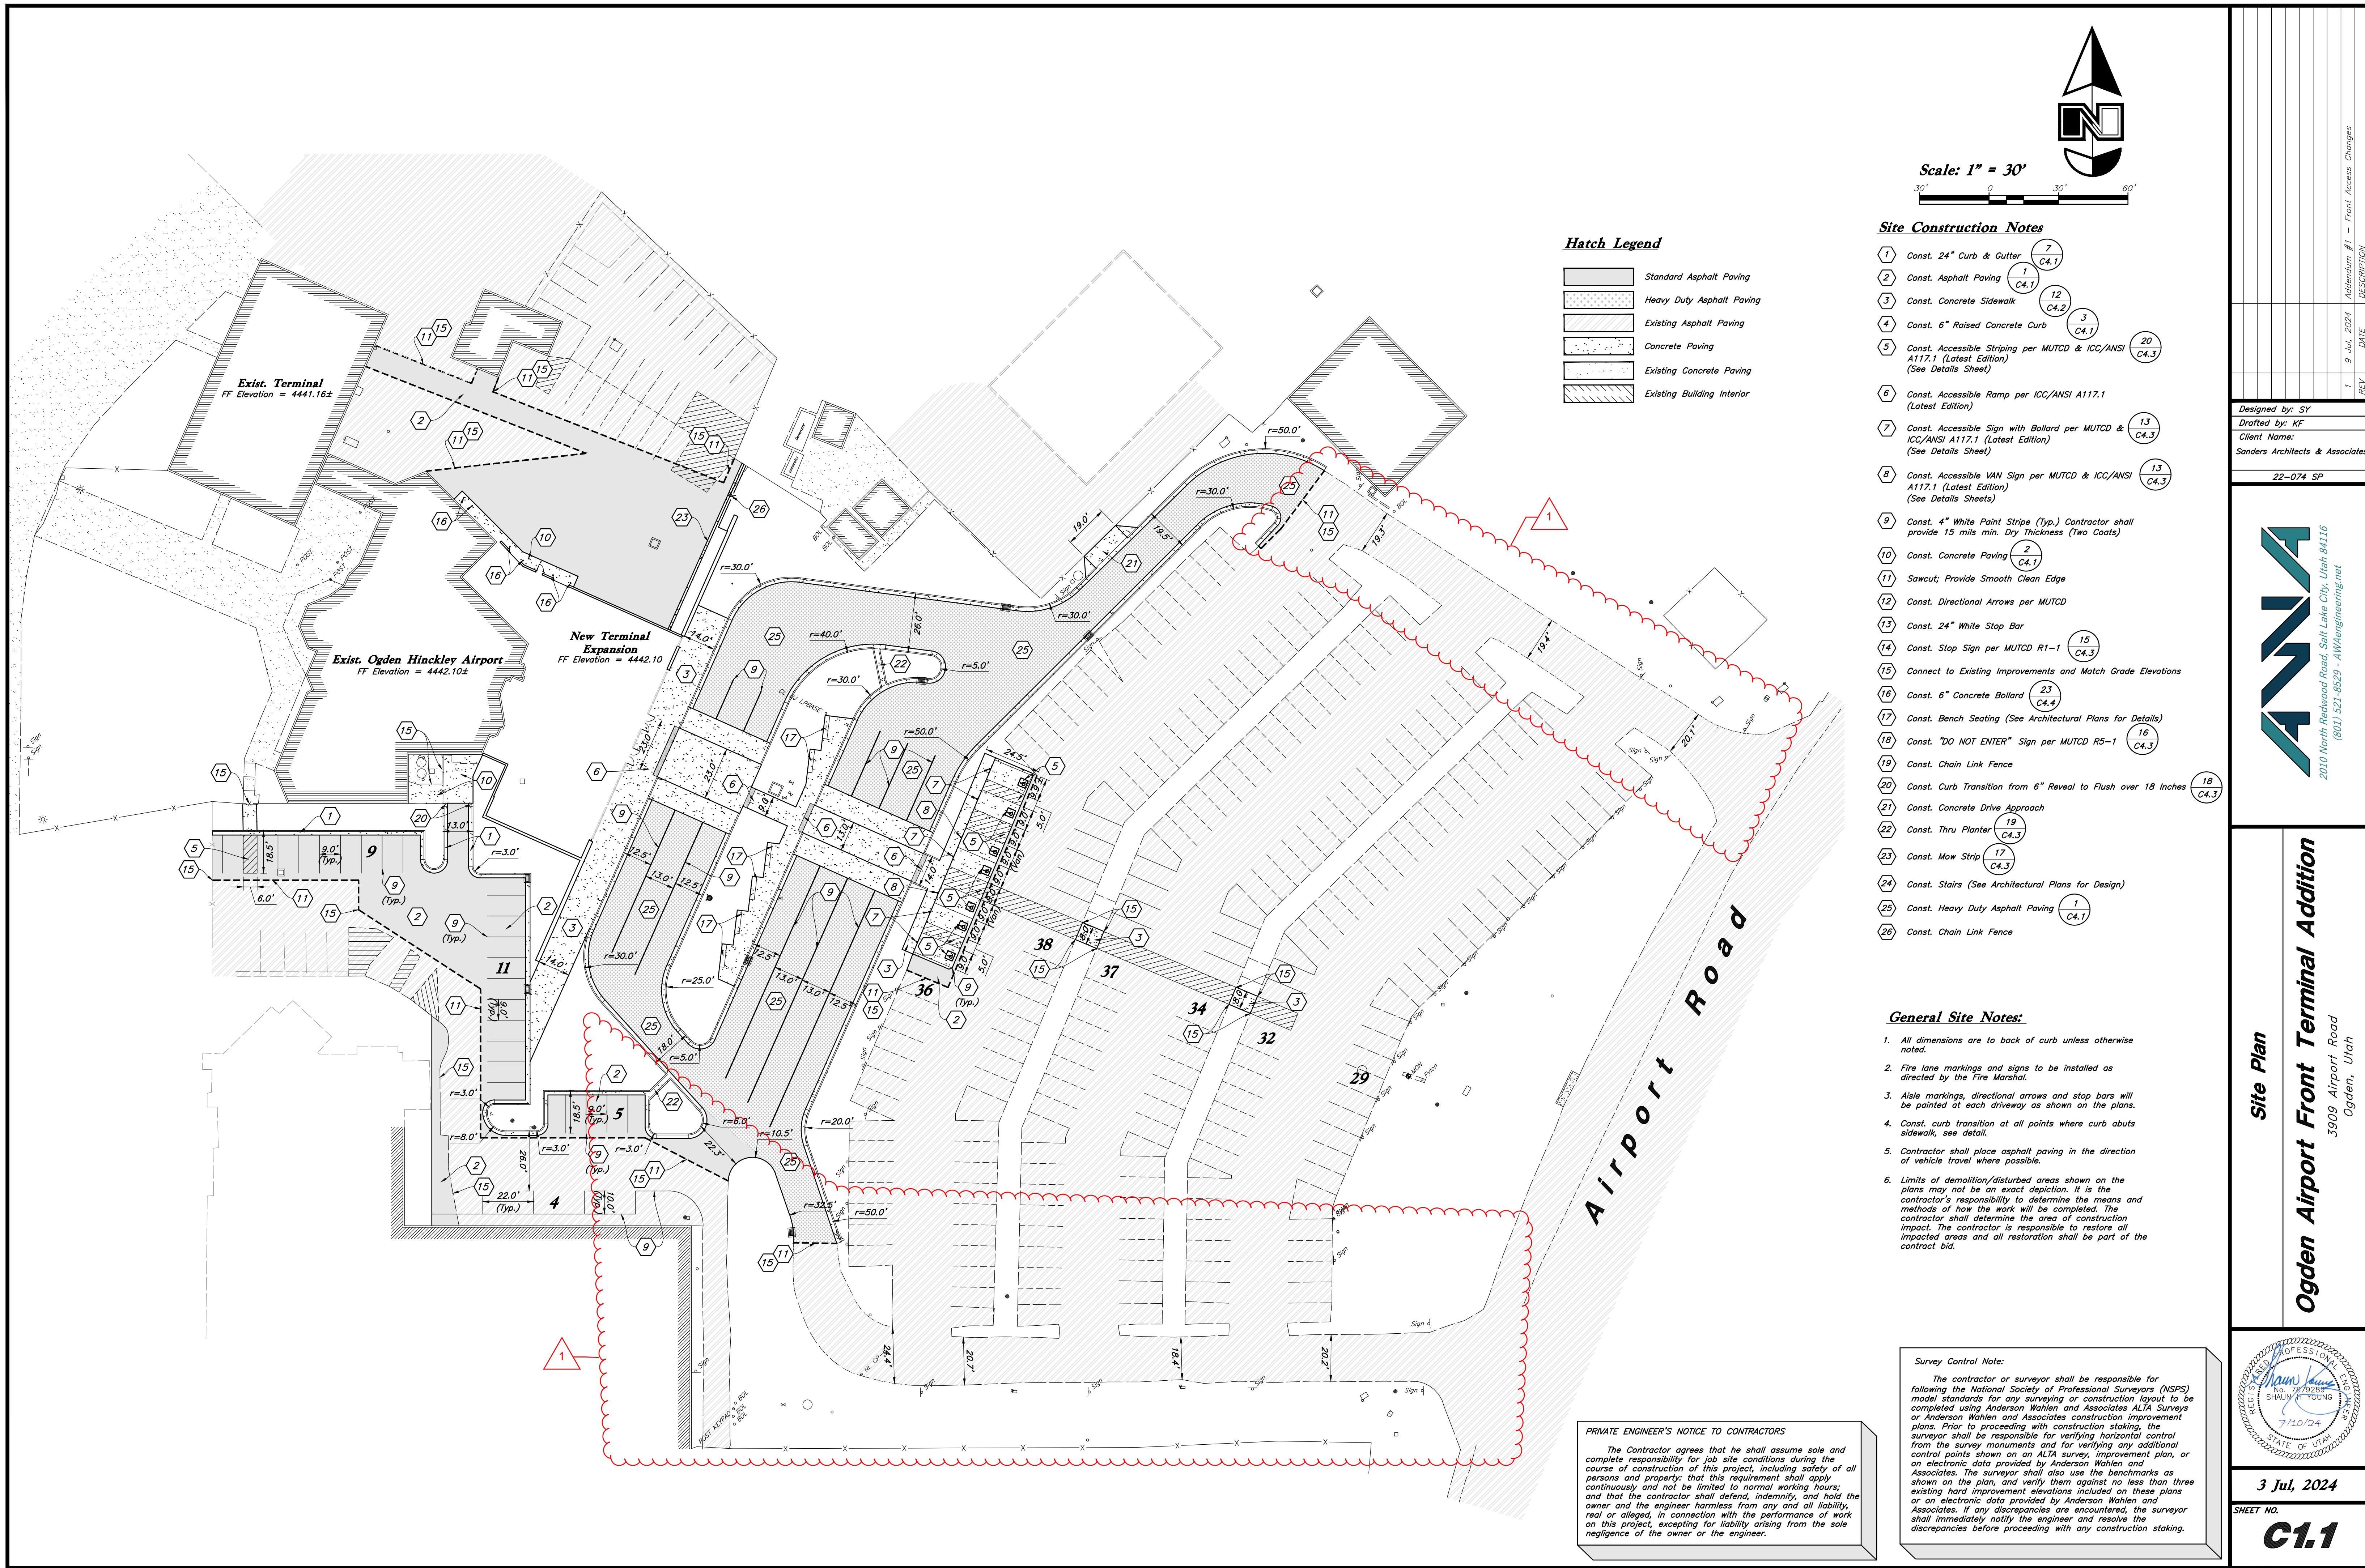
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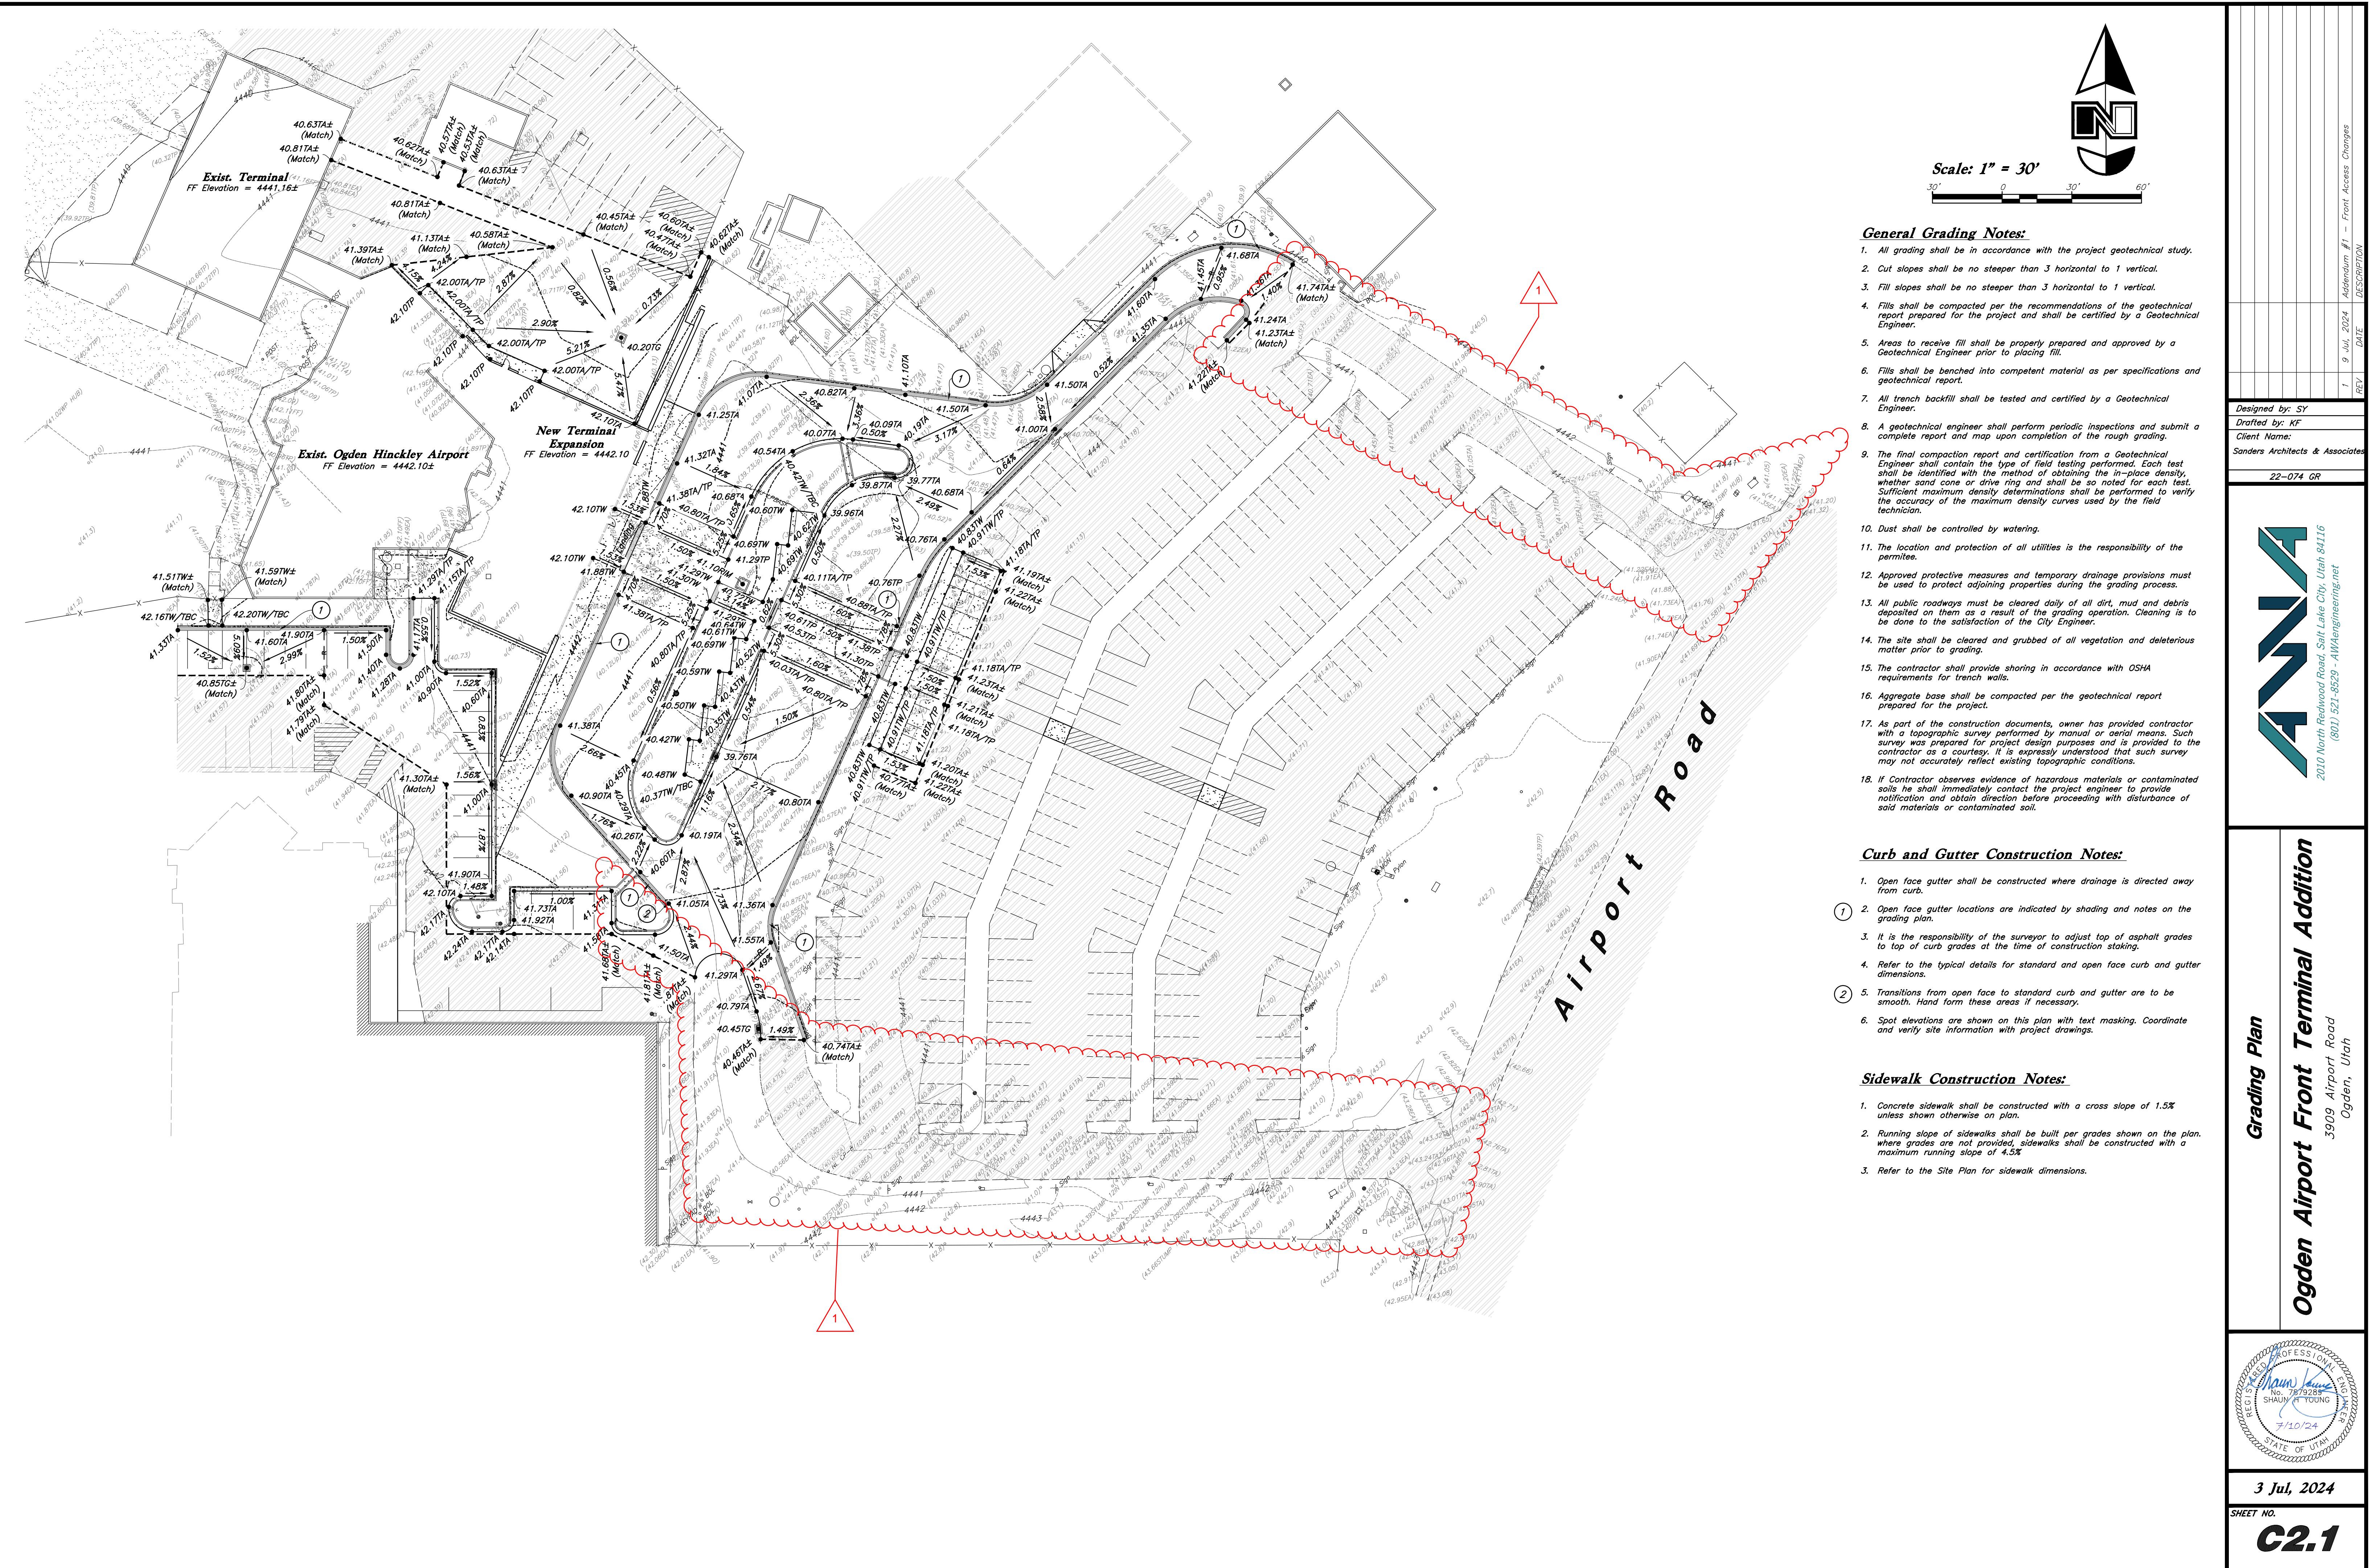
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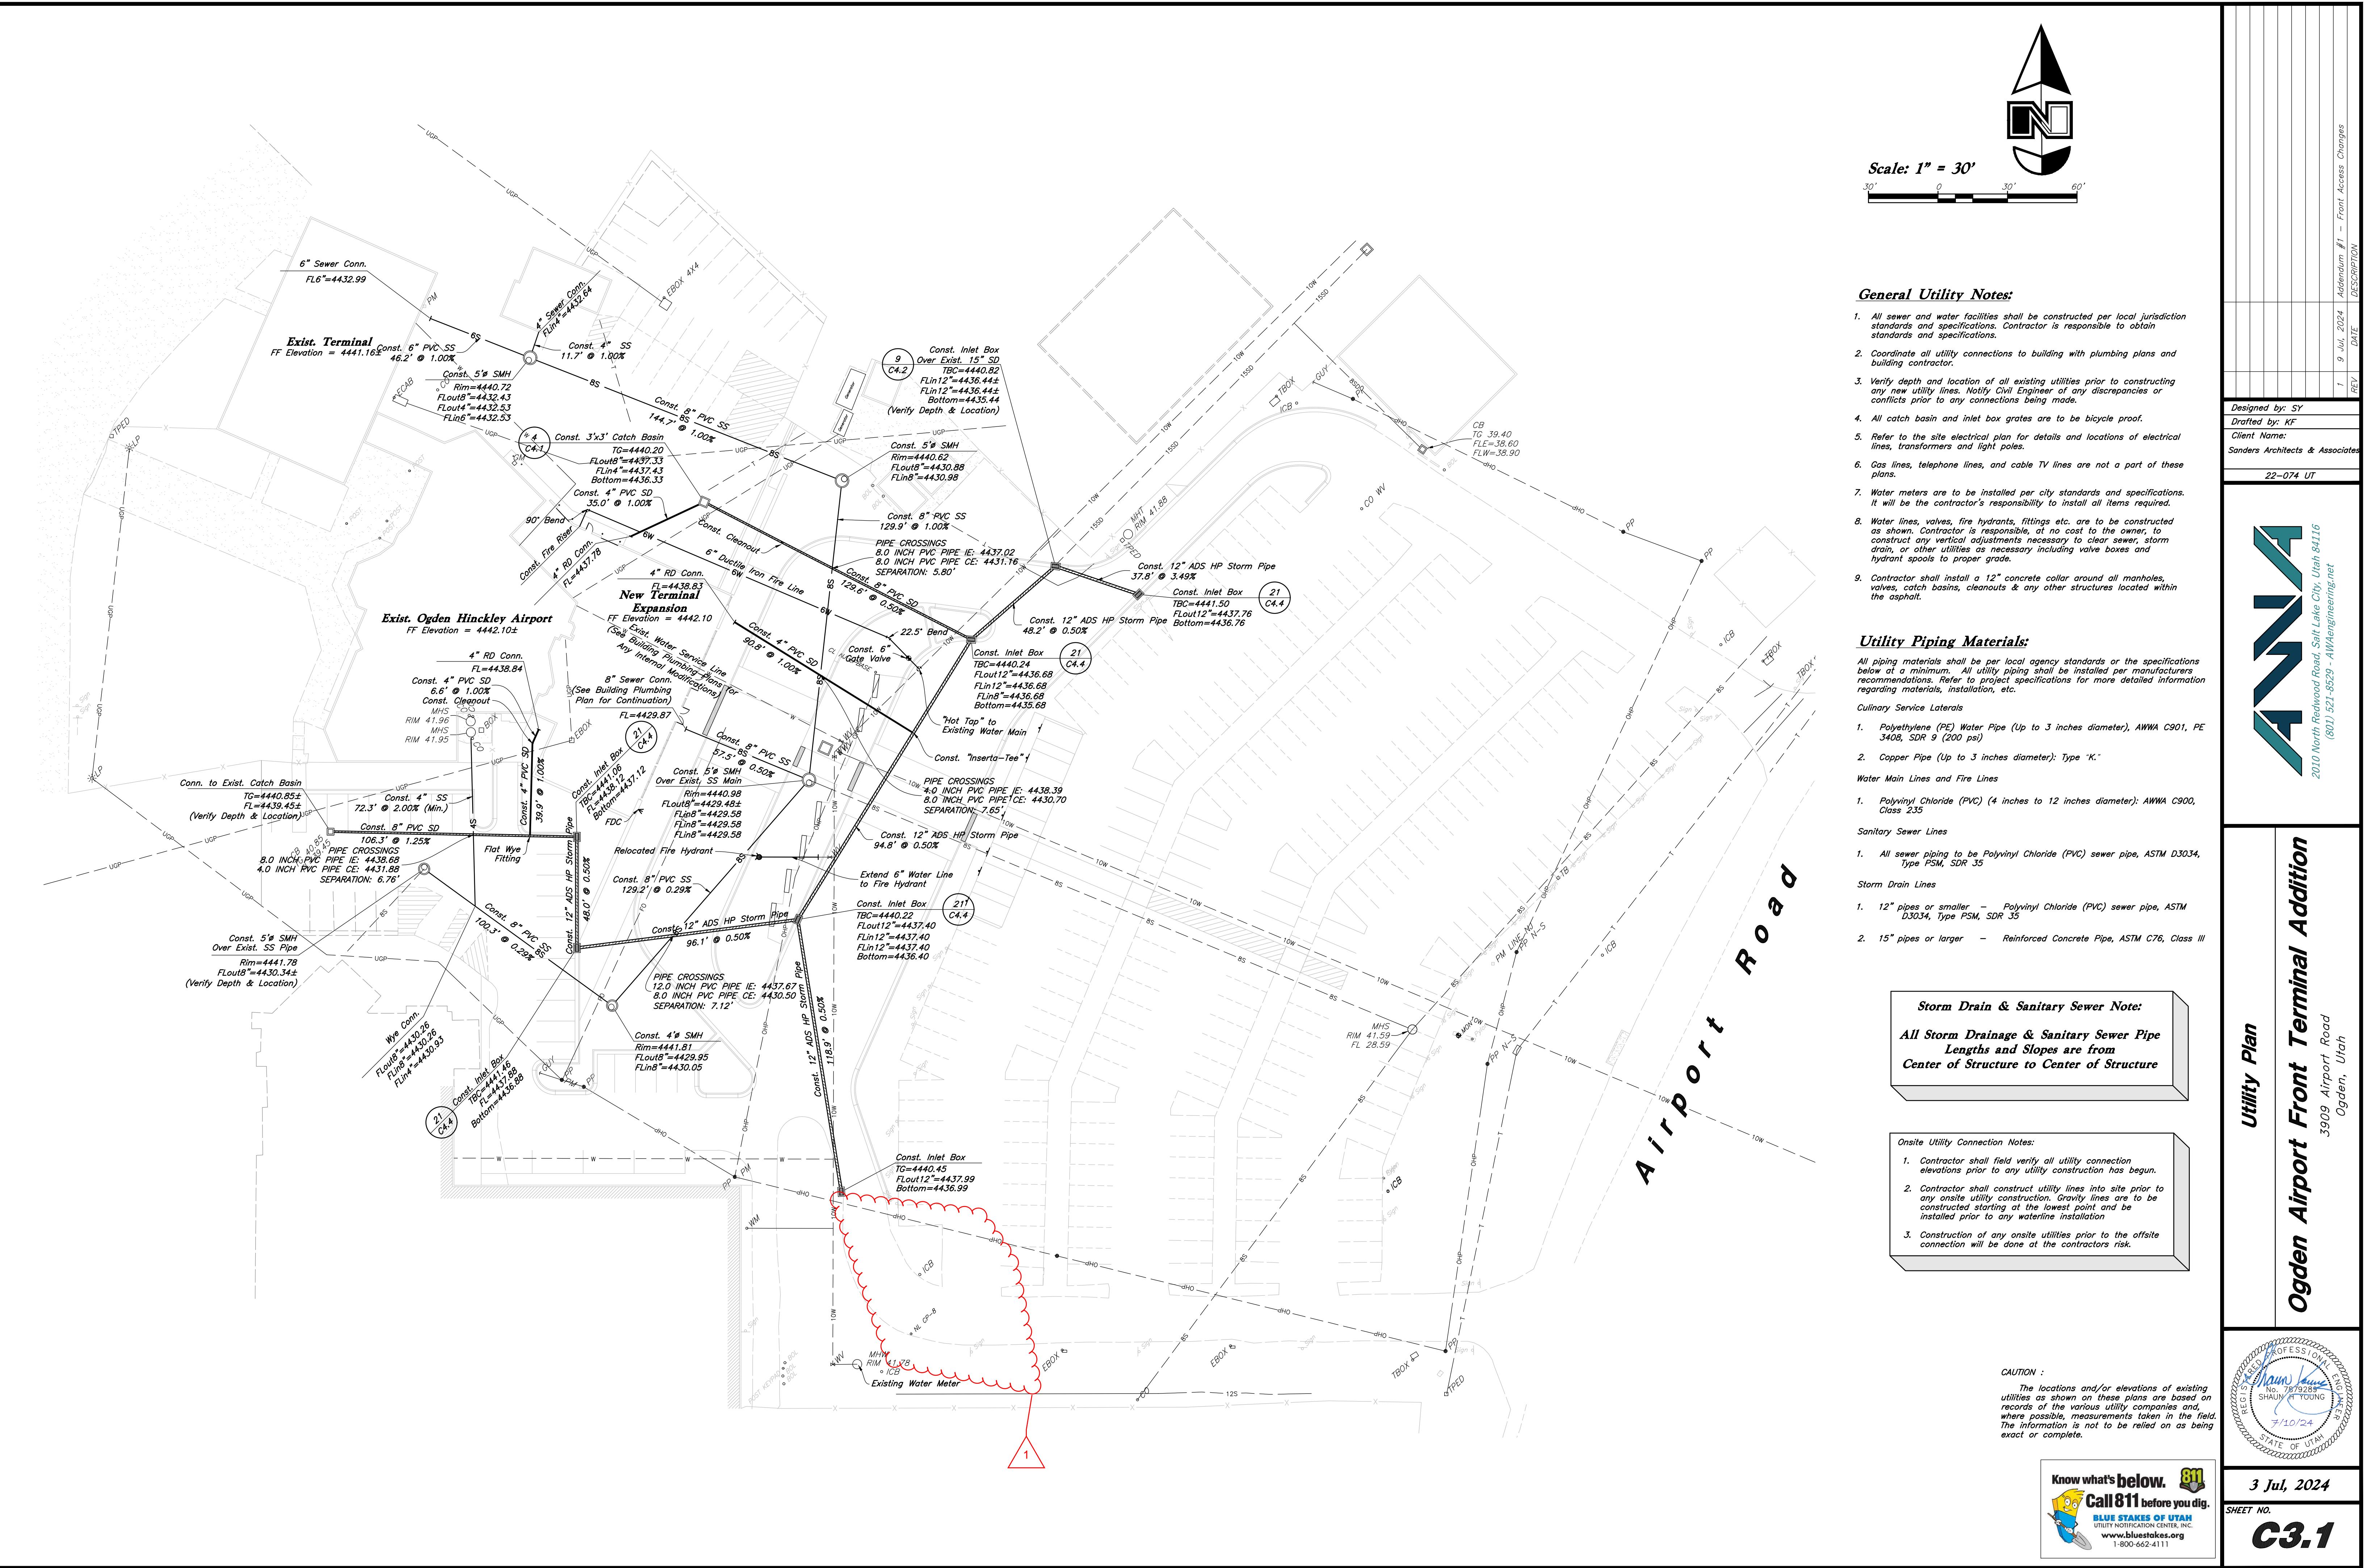
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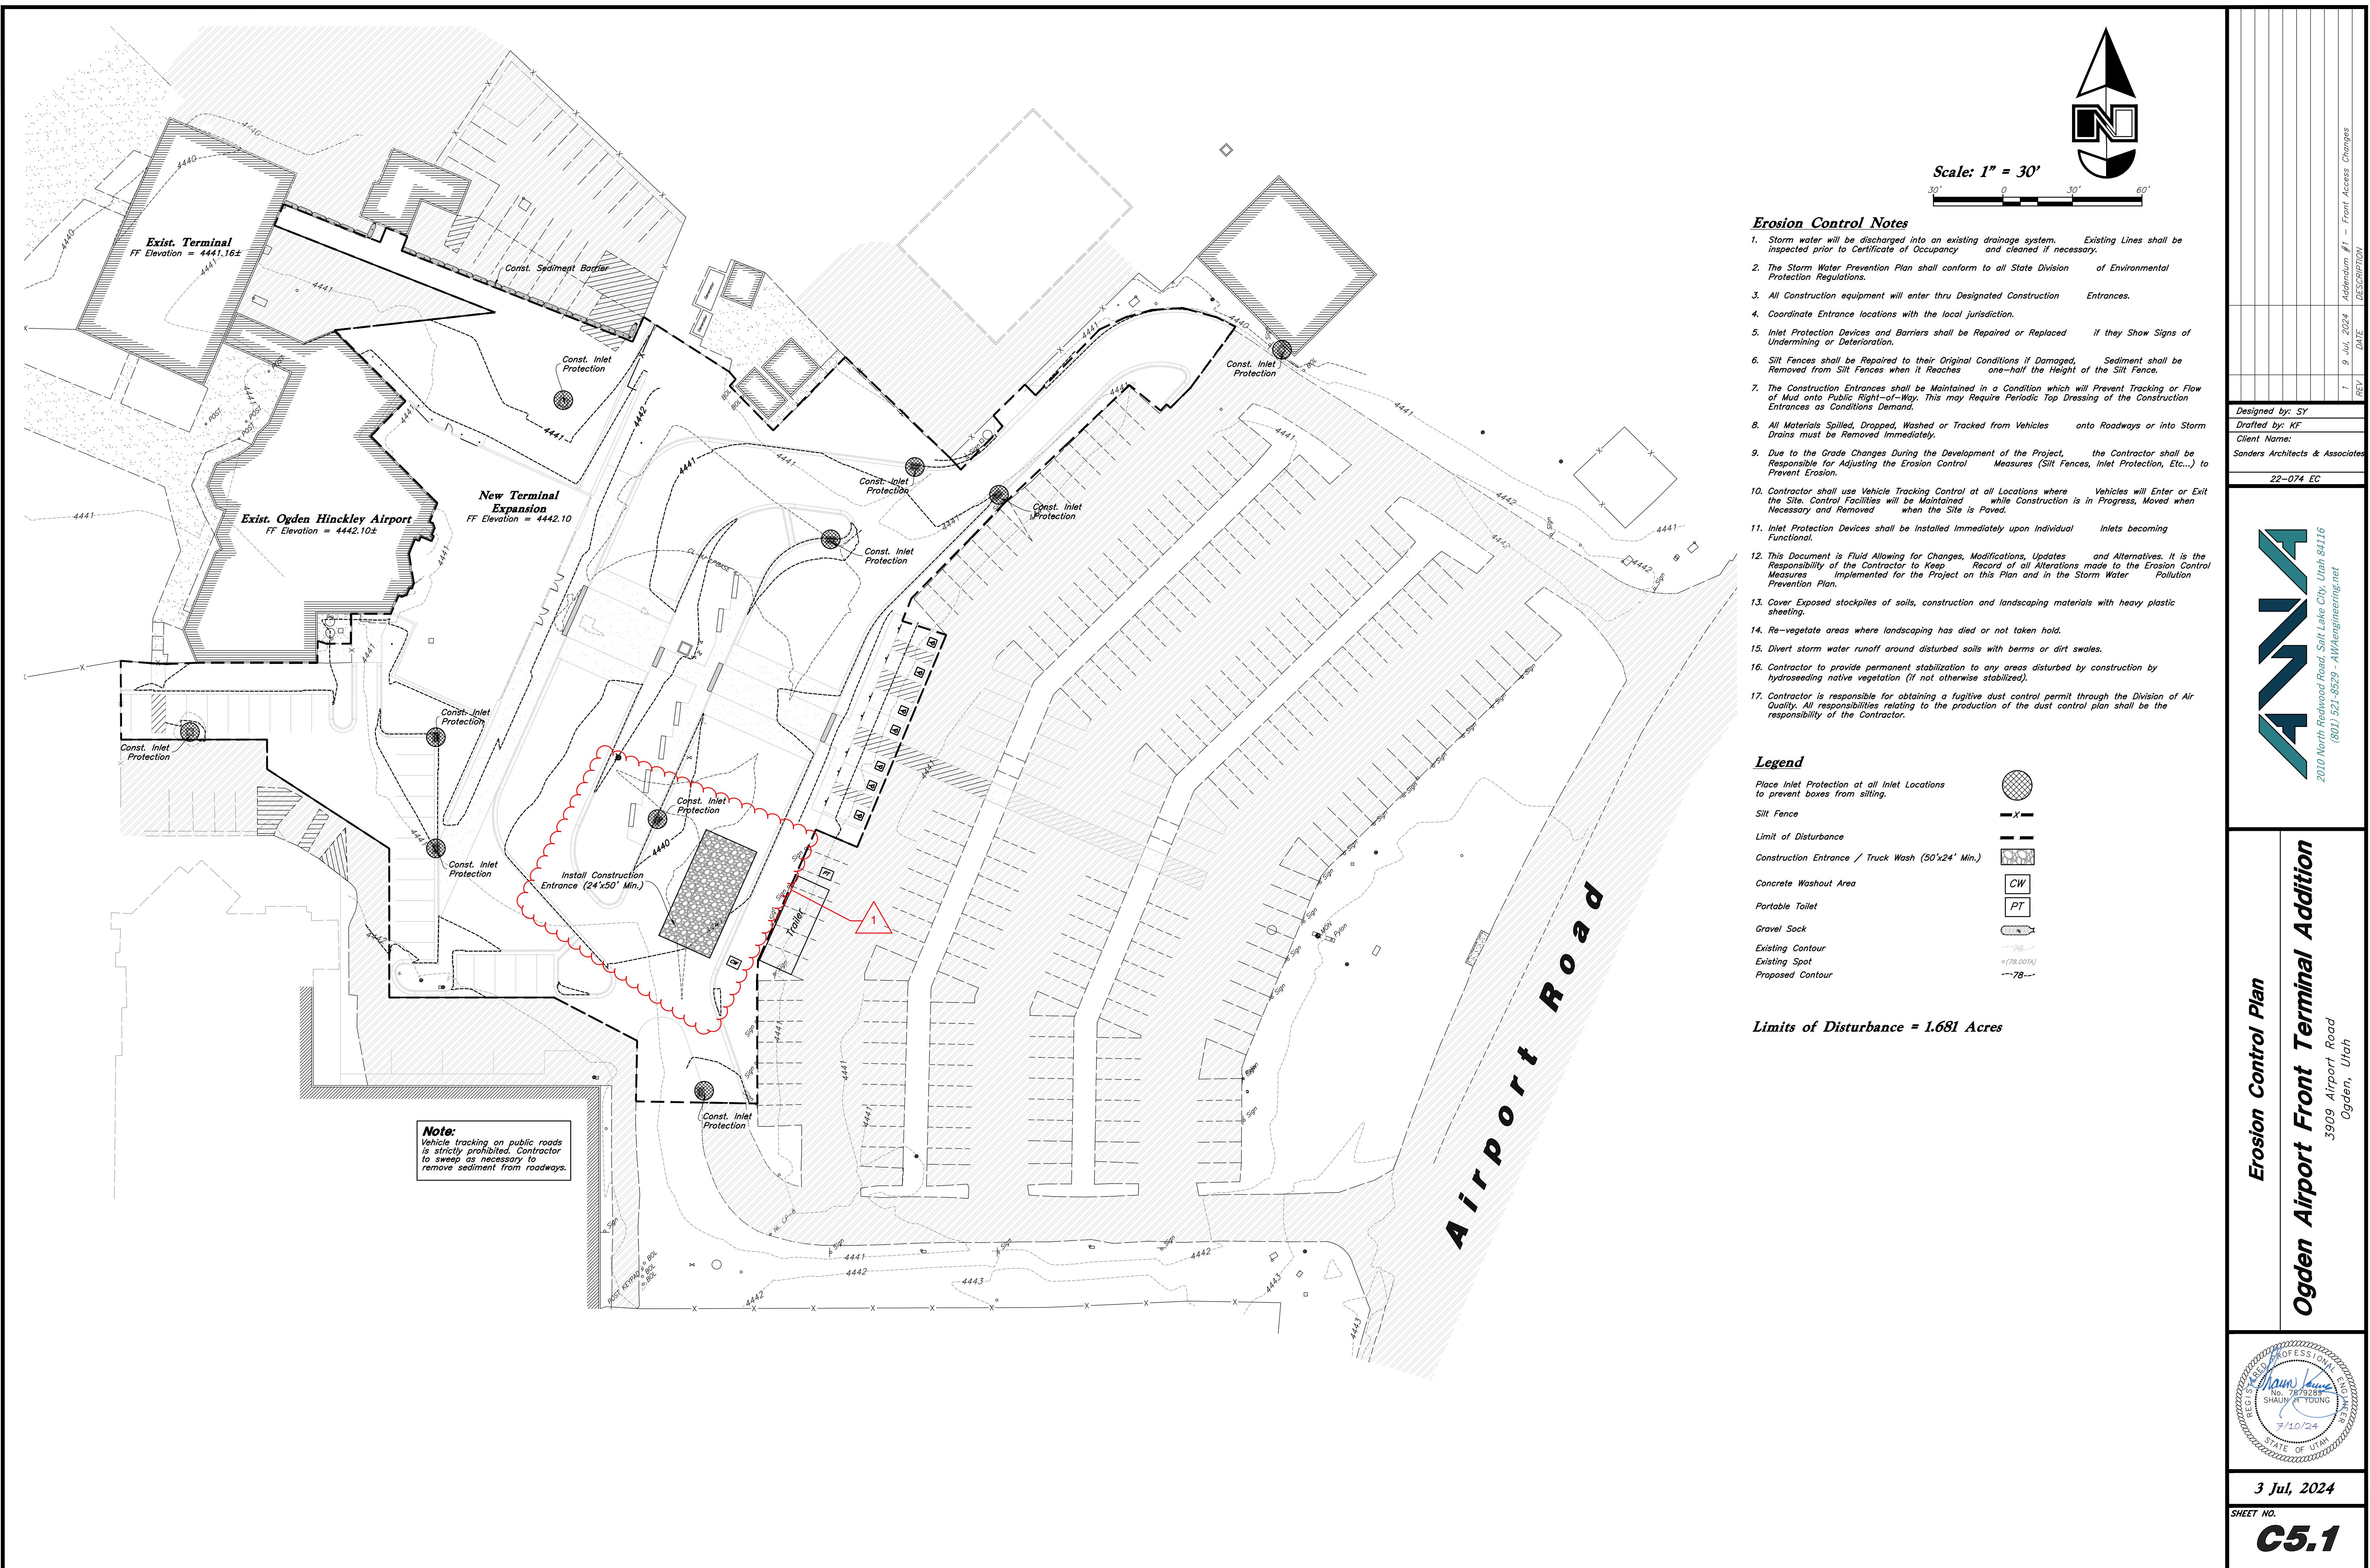
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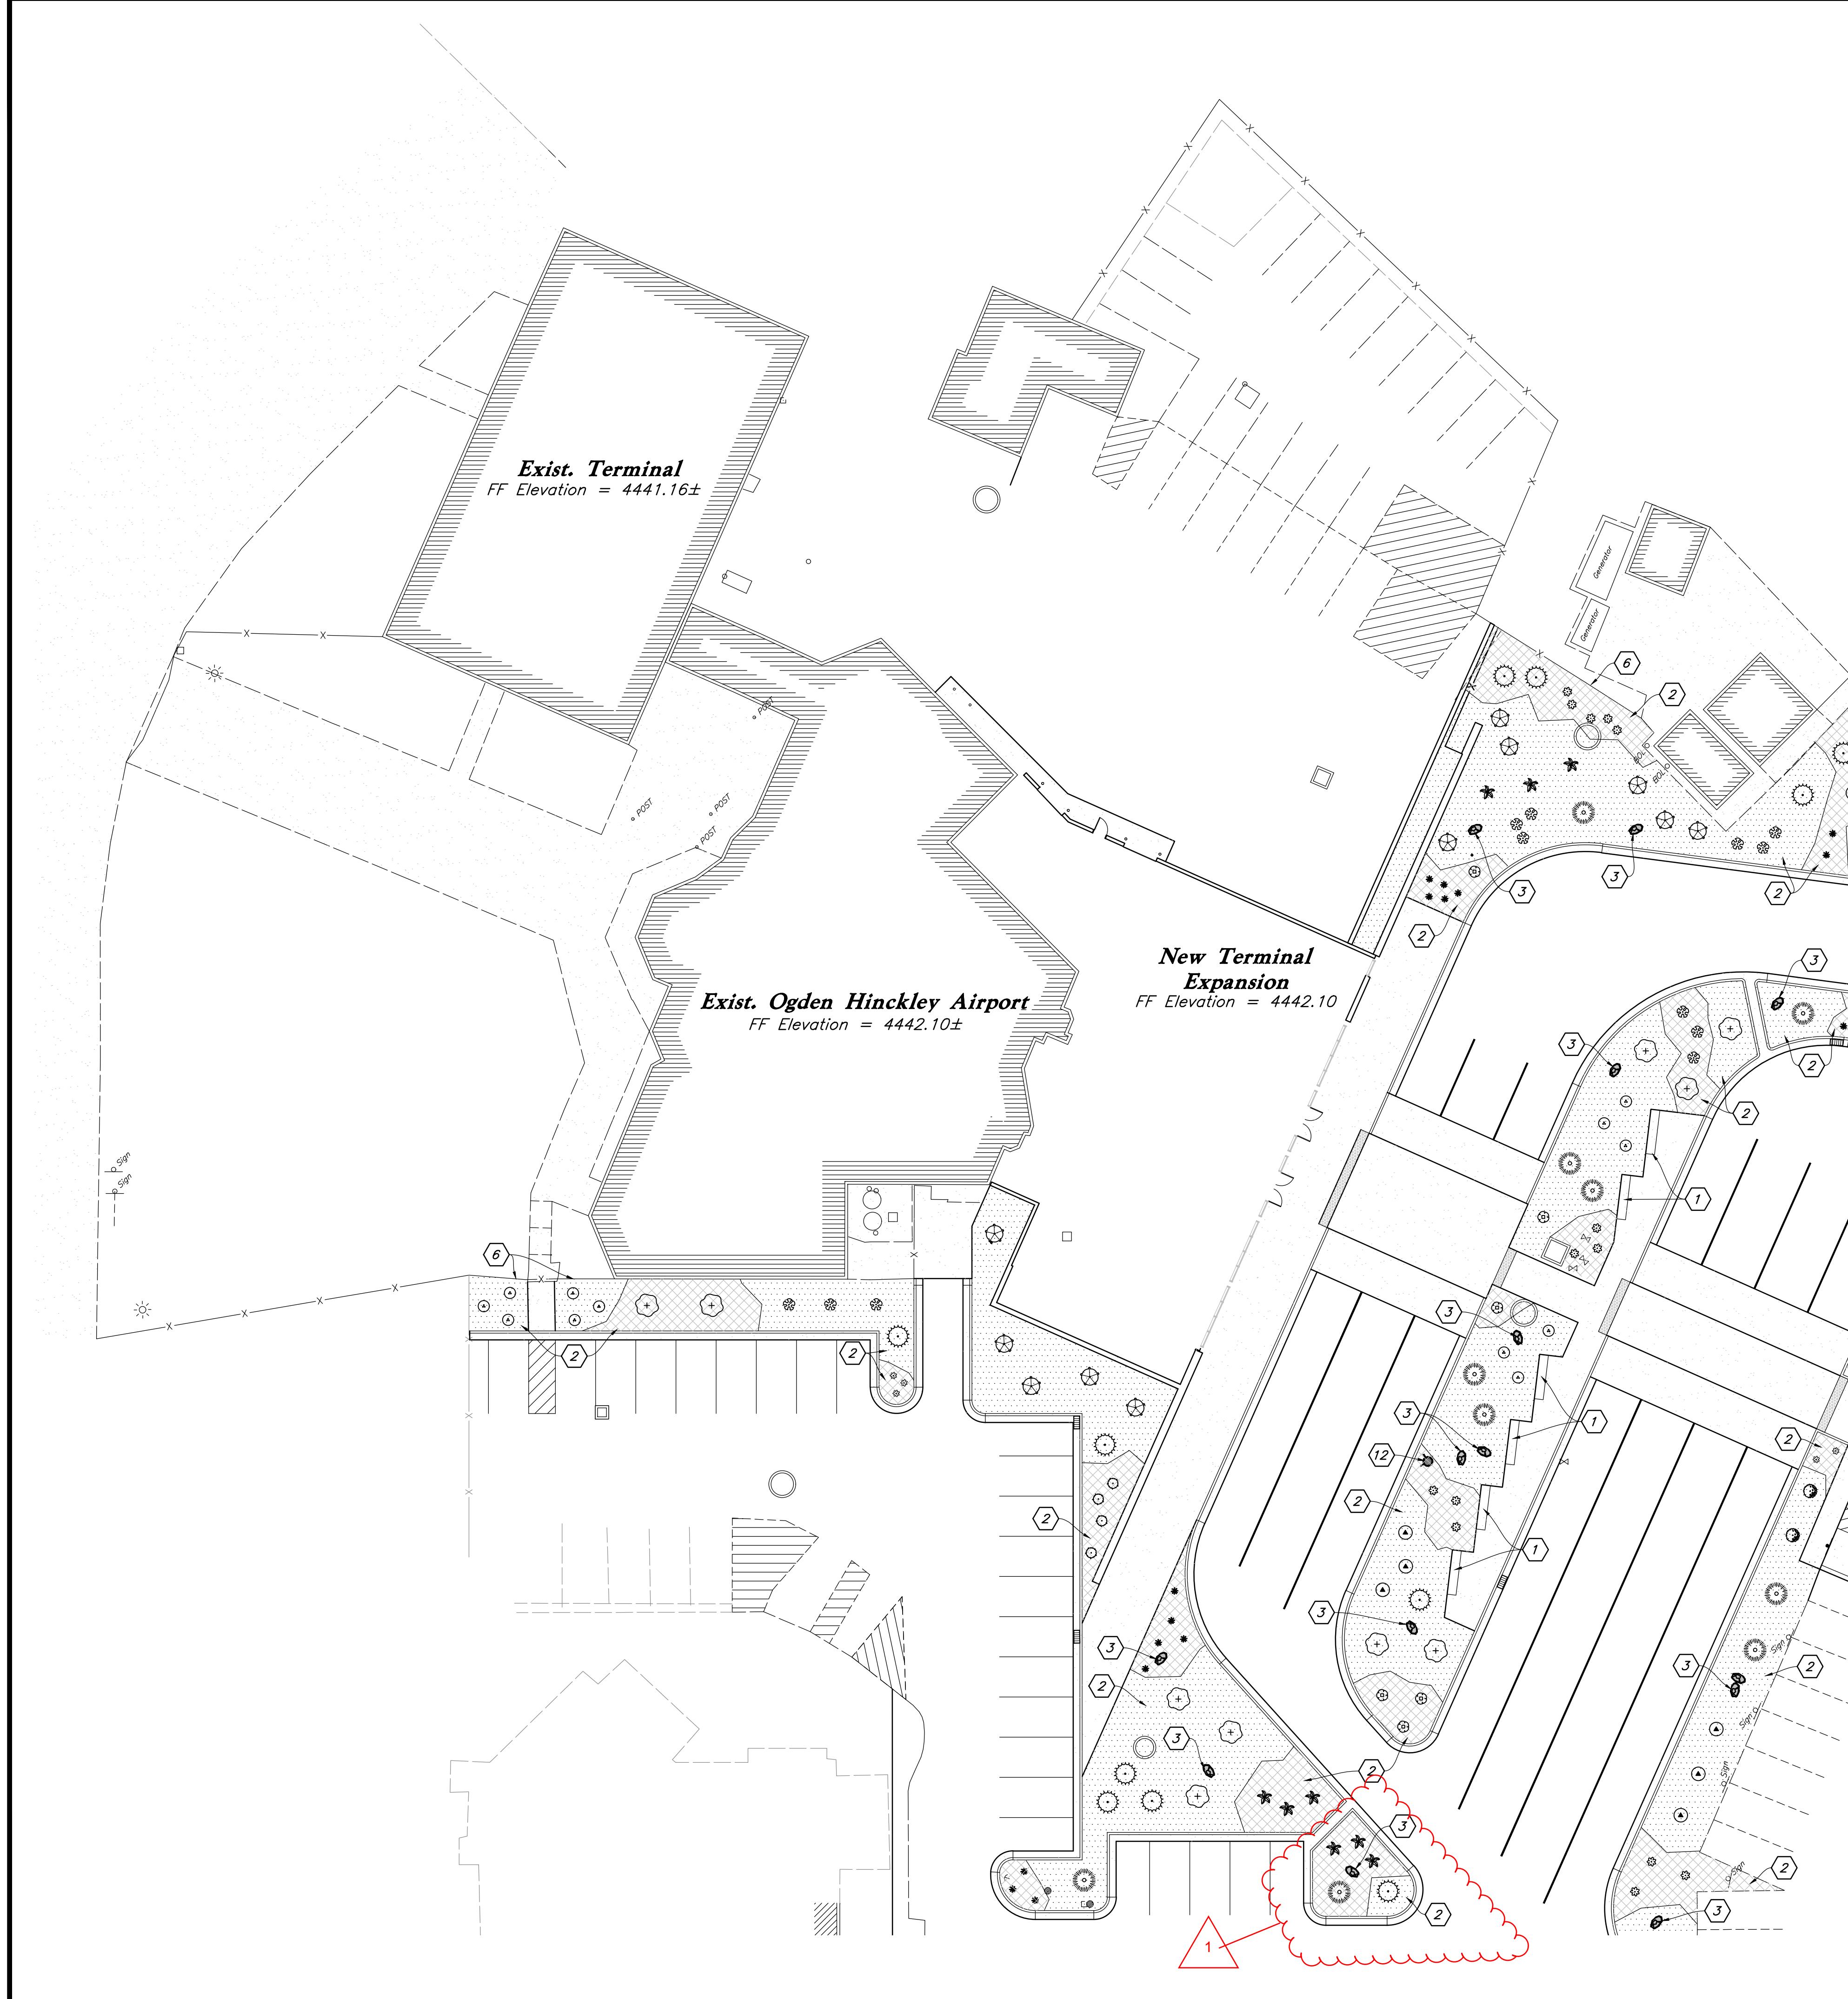











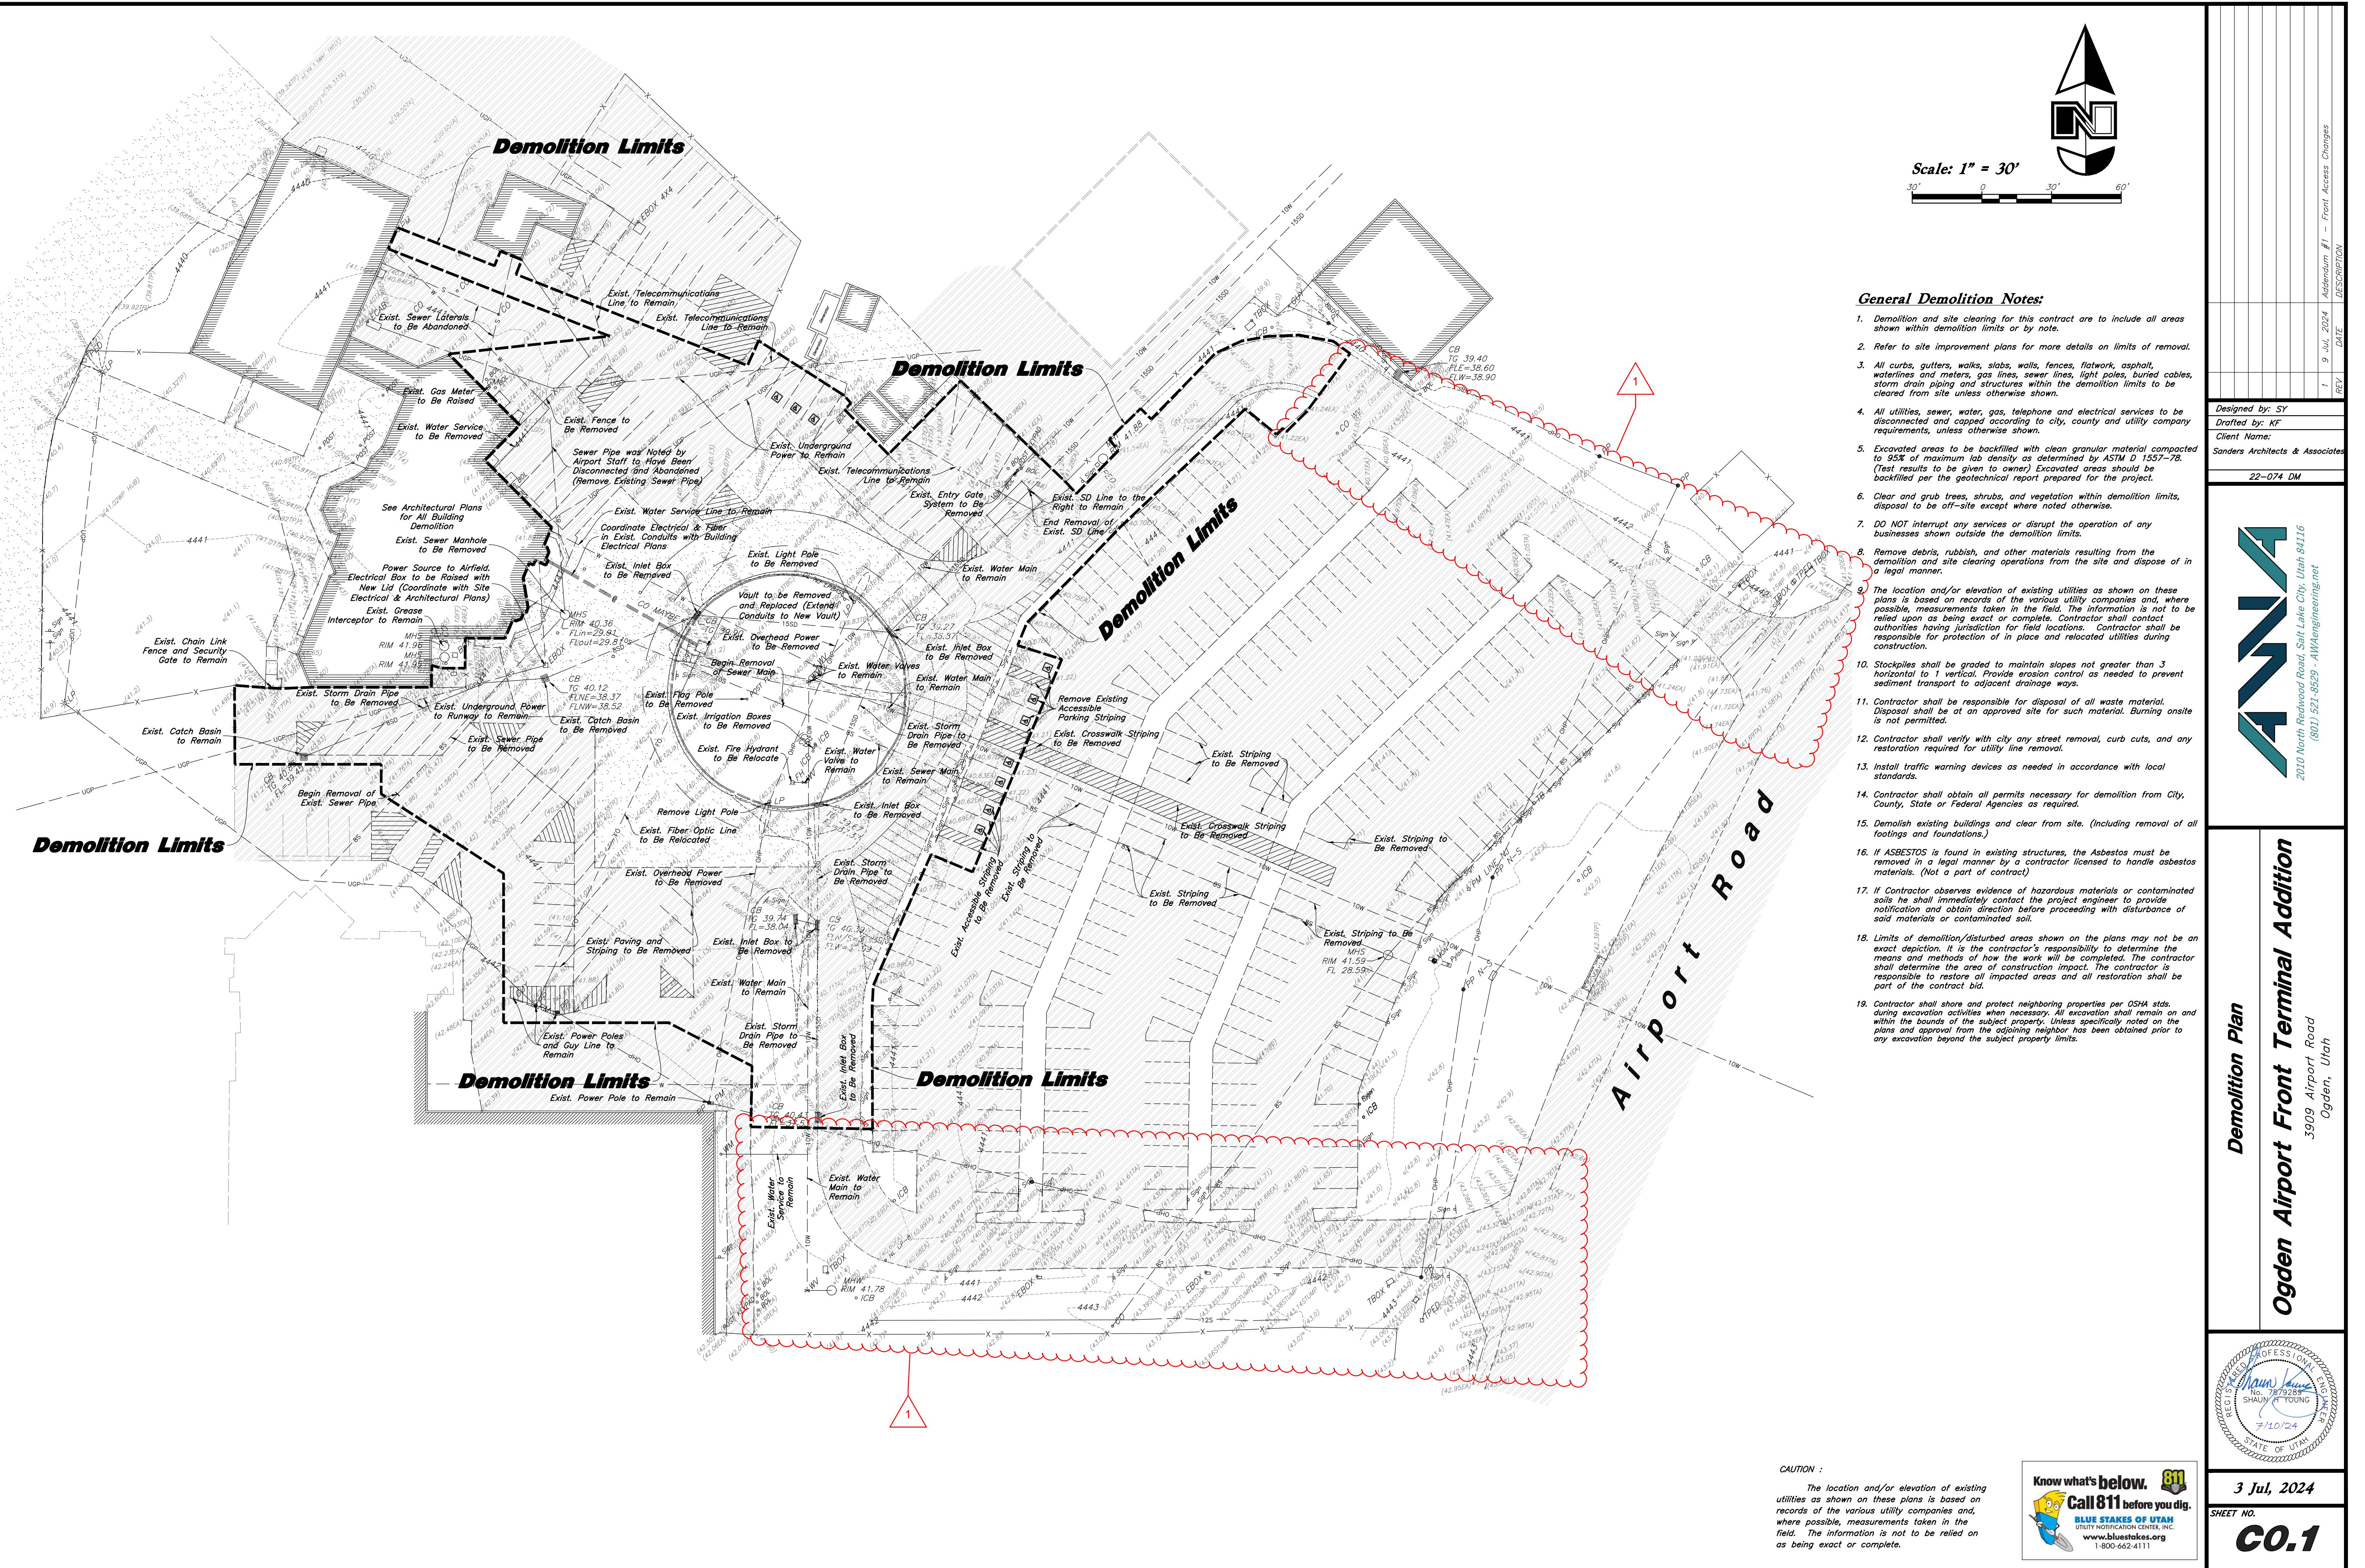

**Landscape Keynotes**

- 1 Decorative Bench - See Arch. Plans
- 2 Install Decorative Stone #1 or #2 Over Commercial Grade Weed Barrier; See Material Schedule for More Detail
- 3 Install Landscape Boulder
- 4 Existing Irrigation Backflow Preventer to Remain
- 5 Existing Stone Shall Remain and be Protected; Remove all Existing Weeds, Trash, and Dead Plants; Add Decorative Stone to Cover Weed Barrier Where Needed
- 6 Existing Fence
- 7 Repair and Add New Decorative Stone #2
- 8 Existing Irrigation Water Meter to Remain
- 9 Existing Lawn to Remain and be Protected
- 10 Patch-up Lawn Against New Site Improvements
- 11 Install Landscape Concrete Curbing Between Existing Lawn and New Shrub Planter
- 12 New Fire Hydrant - See Utility Plan
- 13 Existing Karl Forester Grass Shall Remain and Shall Screen Mechanical Equipment
- 14 Existing Area to Remain Native; No Construction Activities Shall Take Place in this Area

**Landscape Data**  
New/Modified Landscape = 19,057 s.f.

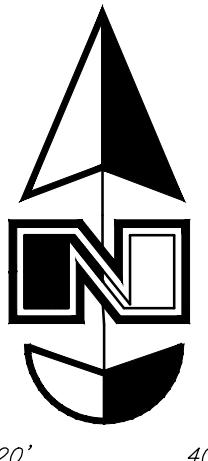

**Landscape Notes:**

1. All New and Existing Landscape Shall be Watered by an Automatic Irrigation System. Paint Source Drip Shall be Used to Irrigate New and Existing Shrub Areas. Existing Irrigation Shall be Reviewed and Modified as Needed to Work with New Irrigation Improvements. See Sheet L2.1-L2.3 for Layout.
2. All Areas that Are Disturbed by Construction that is Not Building and Hardscape Shall be Landscaped. Contact Landscape Architect with Areas in Question. New Landscape Shall Blend into Existing. Repair Damaged Landscape Areas Due to Construction.
3. Adjust Landscape as Needed to Accommodate New and Existing Utilities. Provide Easy Access to Utilities.
4. Different Stone Types and Sizes Shall Not be Separated by Edging but Shall Have a Defined Distinct Edge.
5. Remove all Unused Landscape and Irrigation Material From Site.
6. New Trees Have not Been Incorporated into the Landscape to Prevent Birds from Frequenting the Area and Creating a Potential Safety Concern with Planes.

Designed by: SY  
Drafted by: KF  
Client Name:  
Sanders Architects & Associates

22-074 LS

**AWWA**  
2010 North Redwood Road, Salt Lake City, Utah 84116  
(801) 321-5529 - AWAAengineering.net

**PLANT SCHEDULE**

**SYMBOL QTY BOTANICAL / COMMON NAME**

**SHRUBS**

SYMBOL	QTY	BOTANICAL / COMMON NAME	SIZE
●	4	Cornus sericea 'Kelseyi' / Kelseyi Dogwood	5 gal
▲	7	Forsythia x 'Gold Tides' / Golden Tide Forsythia	5 gal
○	13	Juniperus horizontalis 'Bar Harbor' / Bar Harbor Creeping Juniper	5 gal
●○	16	Physocarpus opulifolius 'Diablo' / Diablo Ninebark	5 gal
●○	14	Pinus mugo 'Pumilio' / Dwarf Mugo Pine	5 gal
○○	25	Potentilla fruticosa 'Goldfinger' / Goldfinger Potentilla	5 gal
○○	11	Rhus aromatica 'Gro-Low' / Gro-Low Fragrant Sumac	5 gal
○○	13	Rosa x 'Meigalipio' / Red Drift Rose	5 gal
○○	2	Spiraea x bumalda 'Goldflame' / Goldflame Spirea	5 gal

**ORNAMENTAL GRASSES**

○○○	30	Calamagrostis x acutiflora 'Karl Foerster' / Feather Reed Grass	5 gal
○○○	6	Helictotrichon sempervirens 'Sapphire' / Blue Oat Grass	5 gal

**PERENNIALS**

○○○○	24	Hemerocallis x 'Stella de Oro' / Stella de Oro Daylily	1 gal
○○○○	19	Perovskia atriplicifolia 'Blue Jean Baby' / Blue Jean Baby Russian Sage	5 gal
○○○○	10	Salvia x superba 'May Night' / May Night Salvia	1 gal


**MATERIAL SCHEDULE**

Decorative Stone #1 - Install a Five (5) Inch Depth over Deltit Pro5 Weed Barrier (Commercial Grade); Stone Shall be Used in Specified Shrub Areas and Washed Prior to Installation; Stone Shall be 2-4" Diameter, Tan Colored, Cobble Stone and Match Existing Used in Parking Islands; Remove all Soil From Weed Barrier Prior to Laying Stone; Carefully Install Around Plant Material, Hand Place as Needed. Detail: 2/L1.3

Decorative Stone #2 - Install on Three (3) Inch Depth over Deltit Pro5 Weed Barrier (Commercial Grade); Stone Shall Cover Weed Barrier; Remove all Soil From Weed Barrier Prior to Laying Stone; Stone Shall be 1 1/2" Diameter Wasatch Gray Stone From Staker Parsons. Detail: 2/L1.3

Landscape Boulders - Boulders Shall be 2-3" in Diameter, Fractured and Match Proposed Stone; Boulders Shall be Recessed into the Stone Two (2) Inches and Not Set on Top of Stone; No Boulder Shall be Placed Adjacent to a Curb Where a Car Could Potential Hit With Bumper or Door. Detail: 3/L1.3

4" x 6" Landscape Concrete Curbing - Install Flush to all Concrete Edges Between Existing Lawn and New Shrub Areas. Curbing Shall be Continuous; Modify Curbing Alignment as Needed to Avoid Existing and New Utilities and Irrigation Boxes. Detail: 4/L1.3

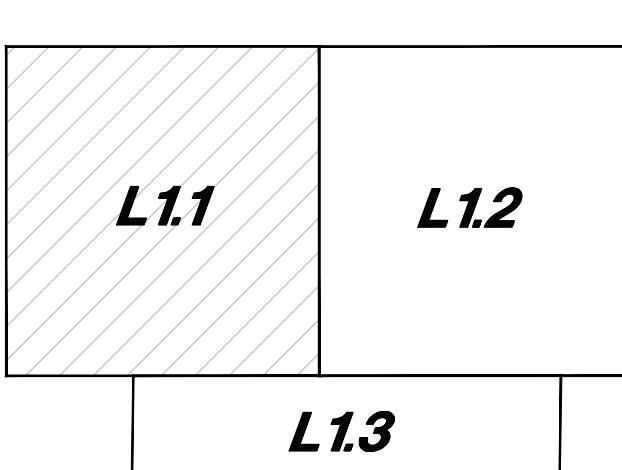


**Key Map**


**811**  
Know what's below.  
Call before you dig.

State of Utah  
Jared L. Mabrey, M.S.C.E.  
No. 774040  
07/10/2024  
Sod Landscape Architect  
3 Jul, 2024  
SHEET NO. L1.1


1 9 Jul, 2024 Addendum #1 - Front Access Changes  
DATE  
REV/C  
22-074 LS



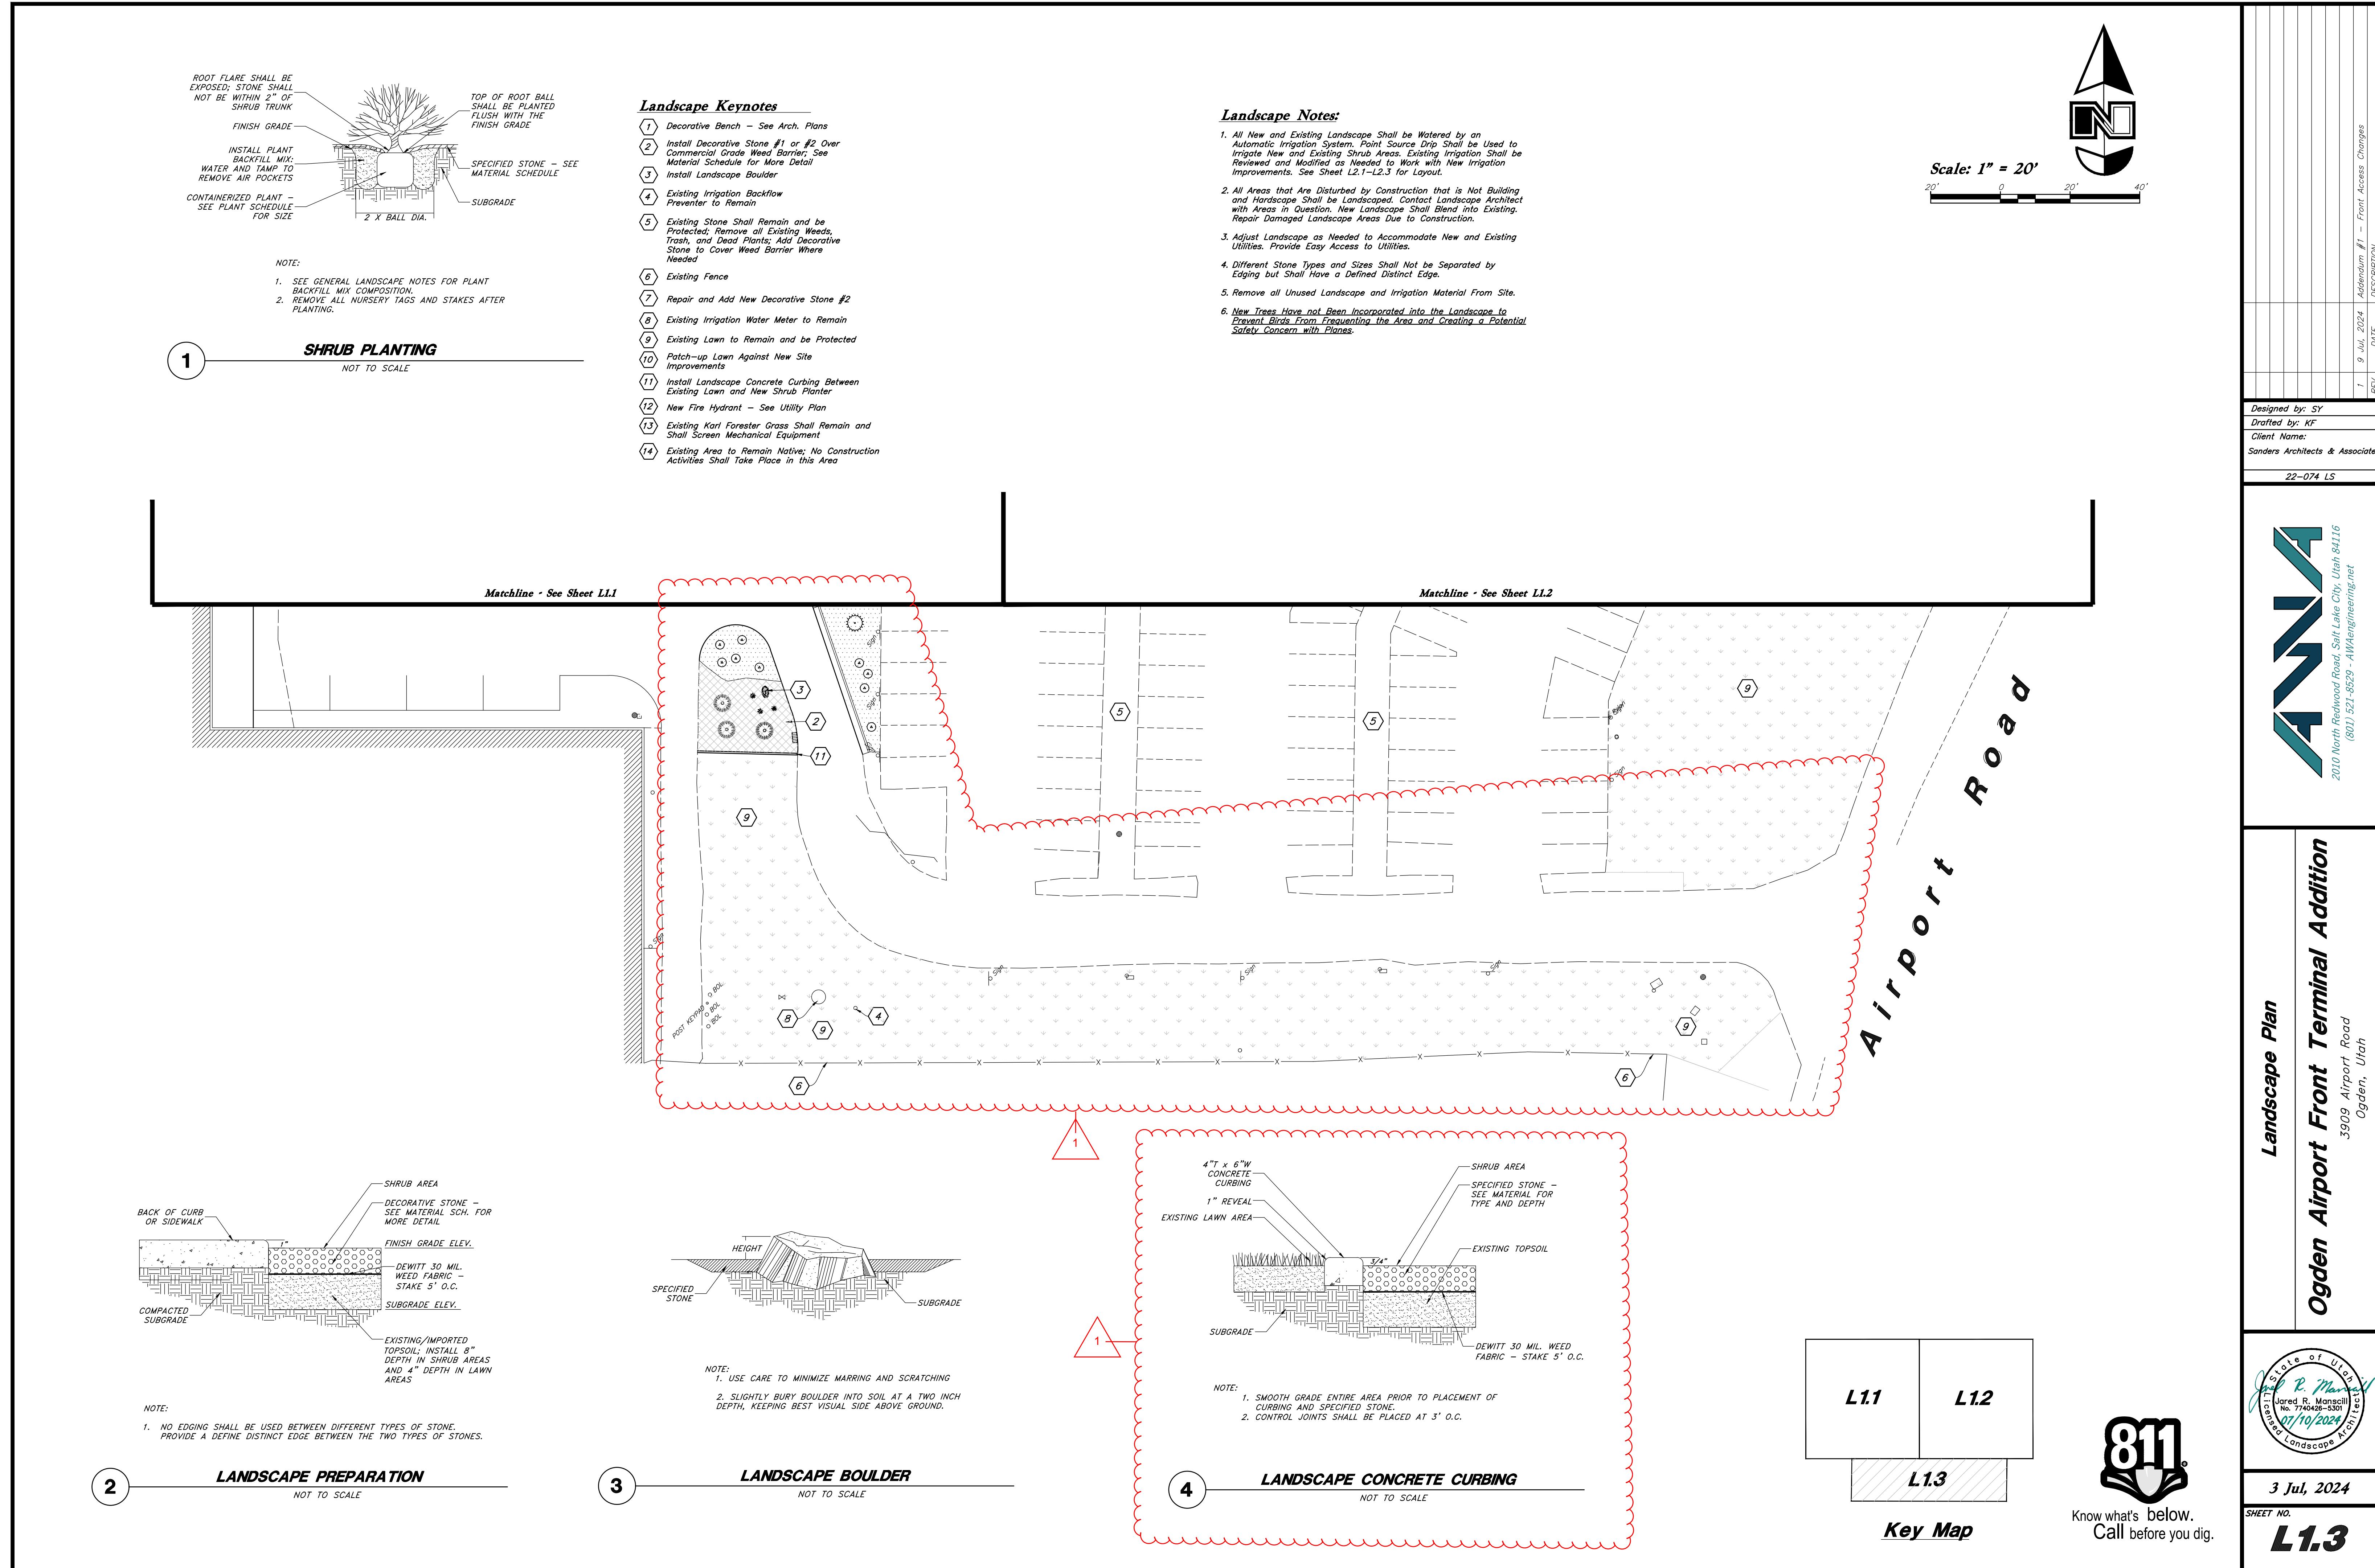

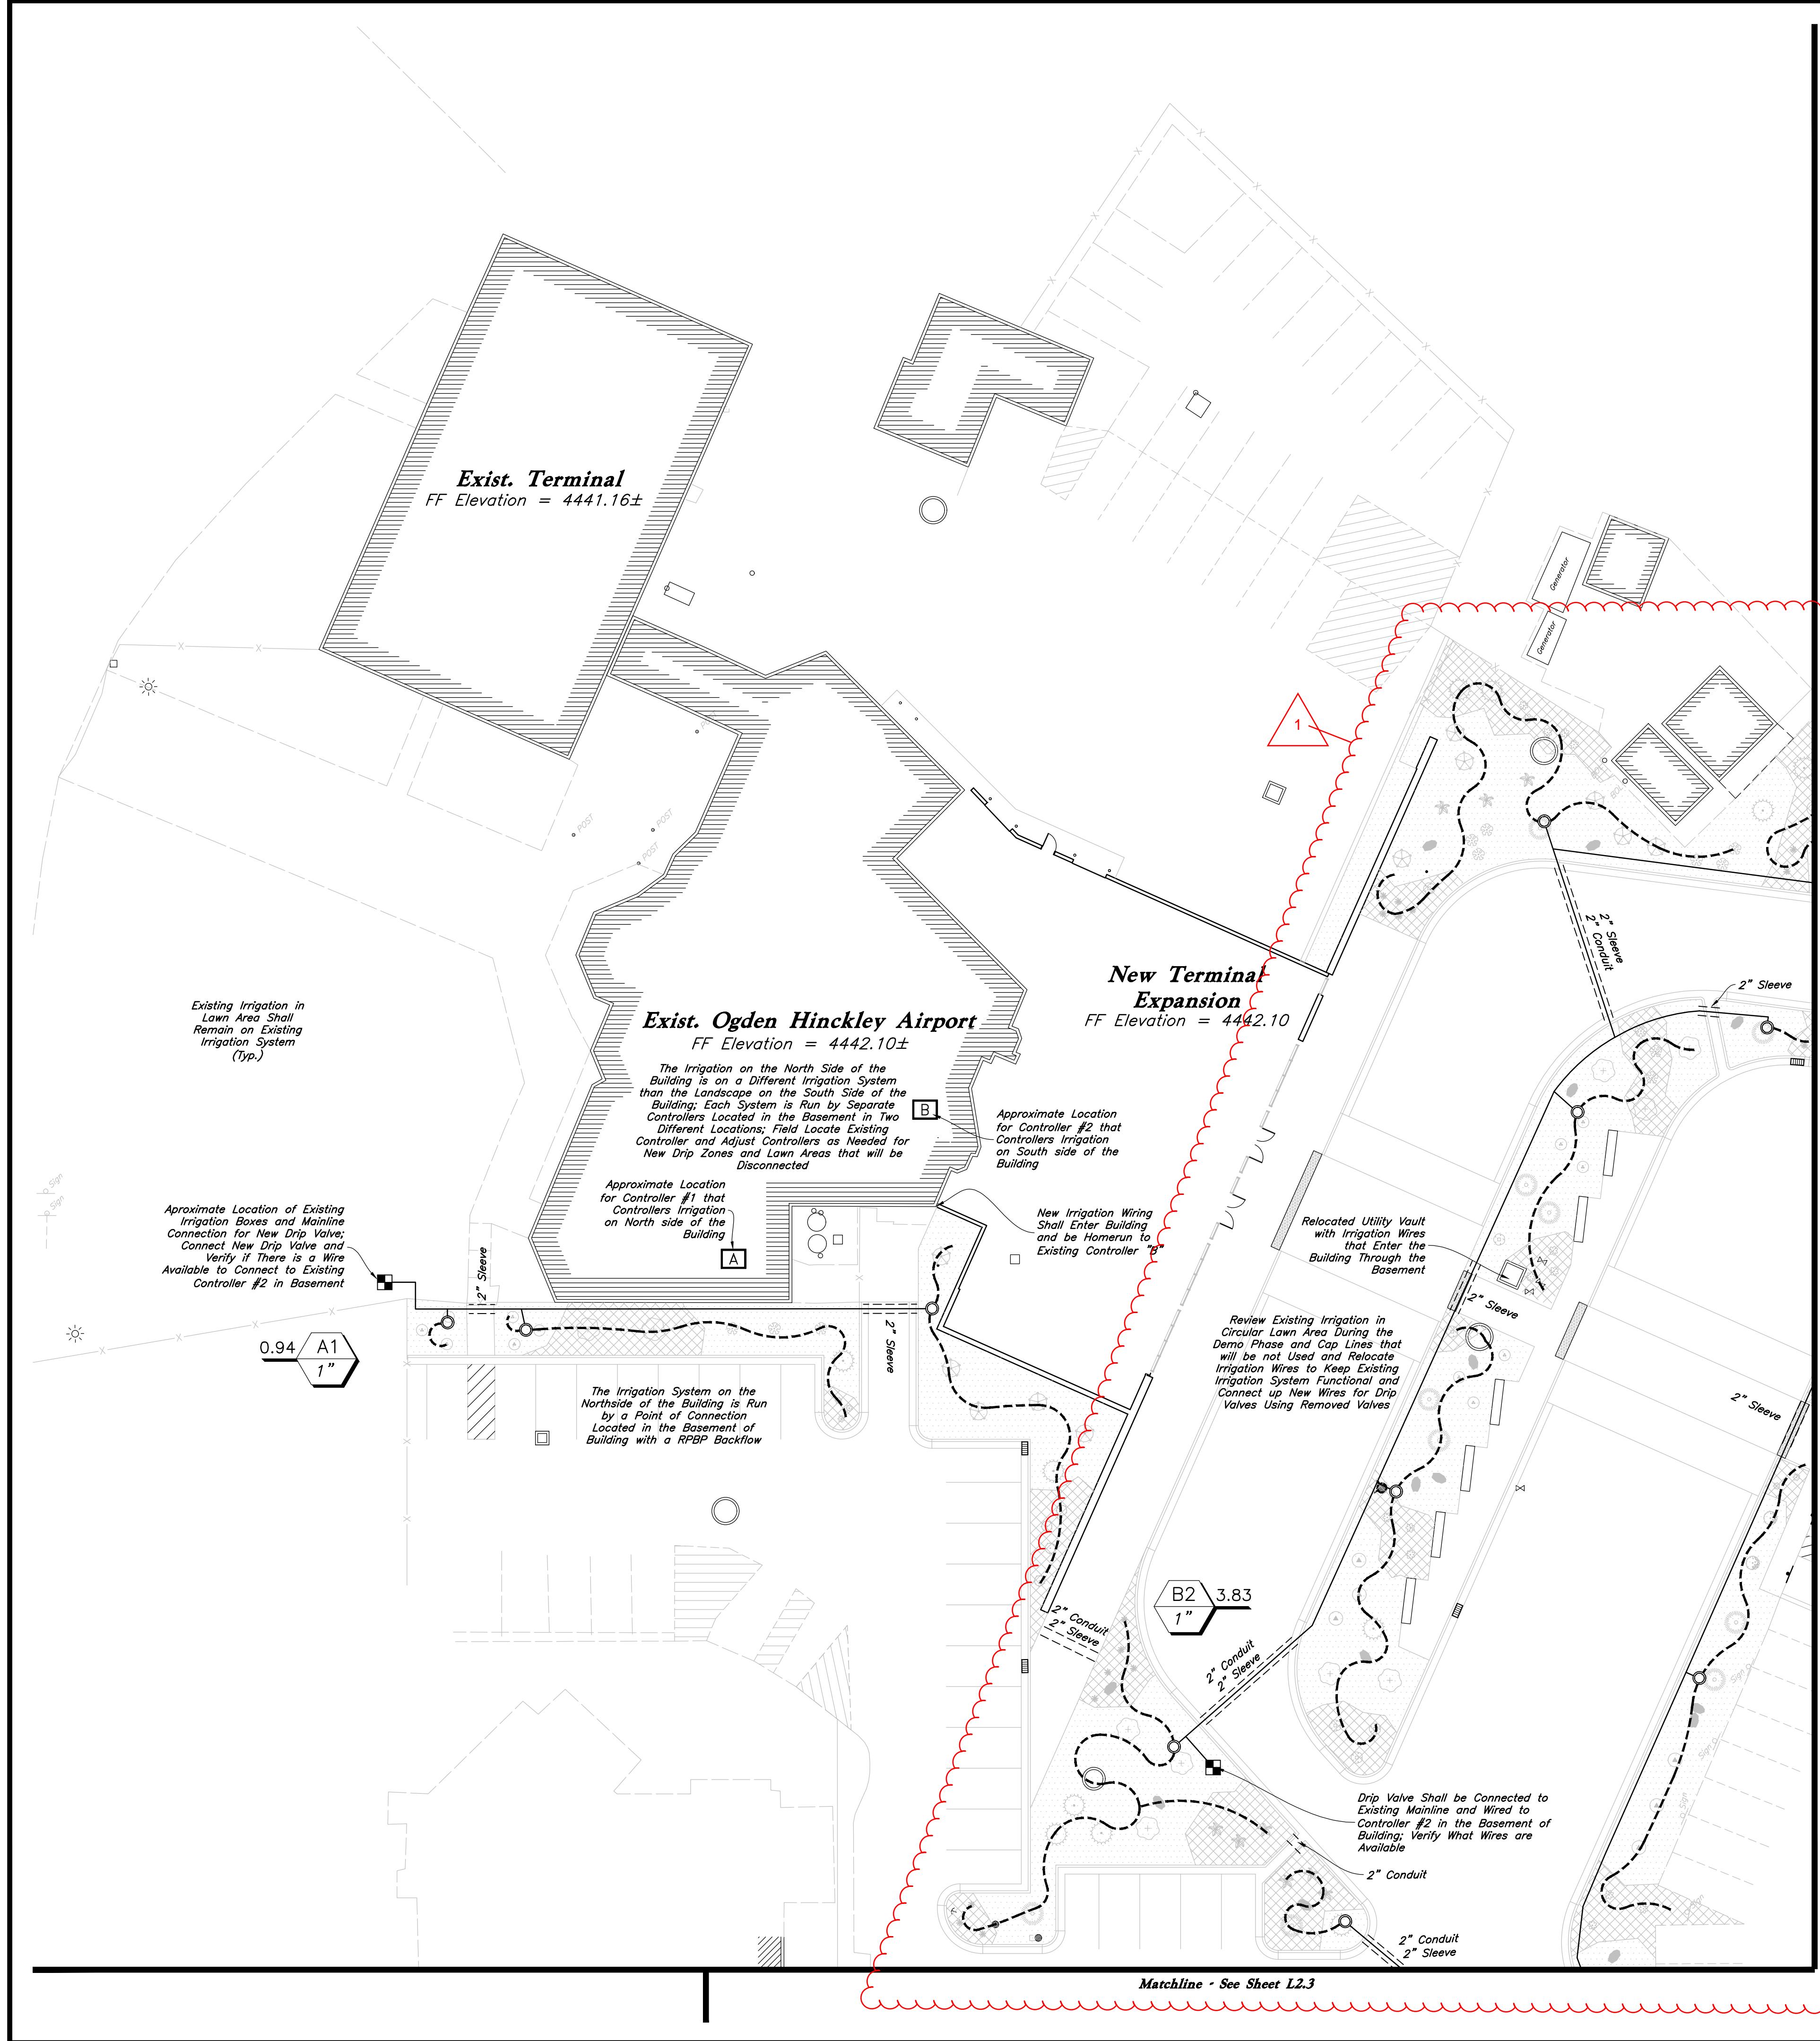

Main Service Line & Other Irrigation Components Are Shown in Paved Or Hardscape Surfaced For Clarity Purposes ONLY! Install All Irrigation Components within Landscaped Areas.

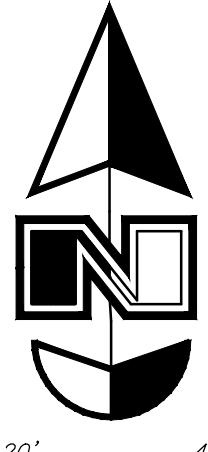

Scale: 1" = 20'  
20' 0' 20' 40'

#### Irrigation Notes

1. See Sheet L1.1-L1.3 for Plant Layout and Details.
2. See Sheet L2.2 and L2.3 for Irrigation Details.
3. The Two Existing Irrigation Systems Shall Remain and be Modified to Keep Systems Functional During All Stages of Construction to Keep Existing Lawn Alive. Retrofit Systems for New Drip Valves and Utilize Existing Wires.

**AWA**  
2010 North Redwood Road, Salt Lake City, Utah 84116  
(801) 321-5529 - AWEngineering.net

**Ogden Airport Front Terminal Addition**  
Irrigation Plan  
3909 Airport Road  
Ogden, Utah




3 Jul, 2024

SHEET NO.

**L2.1**



Know what's below.  
Call before you dig.

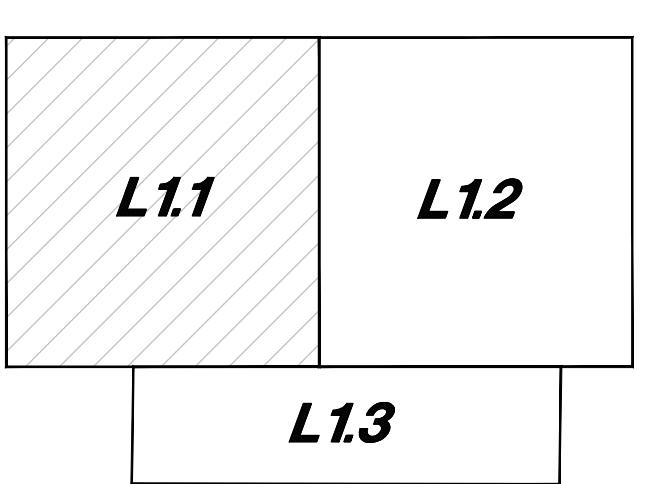

**Key Map**

#### IRRIGATION SCHEDULE

Symbol	Manufacturer/Model #	Description	Notes	Detail
<b>Valves</b>				
■	Rain Bird XCZ-100-PRB-COM	Drip Control Zone Kit	1 Inch Size; Install in Standard Valve Box with 3" Depth of Gravel over Weed Barrier; Install with Water Proof Wire Connectors	3/L2.3
<b>Drip</b>				
○	PVC Pipe To Drip Tubing	Provide Connection Fittings	Install 1" Feeder Line To All Drip Areas	4/L2.3
—	Rain Bird XBS-940 Rain Bird XG-100 Rain Bird XG-100PC Rain Bird TS25 Rain Bird DBC-025 Rain Bird MDCFCAP	3/4" Distribution Tubing - Pipe shown on Plan is Schematic; Adjust Location as Needed 1/4" Distribution Tubing - Install one per Emitter Xent-Bug Emitter (1 Gal/Hr.) - 1(1) per Perennial & Orn. Grass, 2(1) per Shrub Tie Down Stake - Tubing to be Staked every 3' Diffuser Bug Cap - Install one per Emitter Removable Flush Cap - Install at the End of Each Line		1/L2.2 5/L2.3
<b>Existing P.O.C.s</b>				
		Existing Irrigation P.O.C. Shall Remain and Stay Functional; Each System had a RPBP Backflow; The System on the North P.O.C. is Located in Basement of Building and the Irrigation Connection on the South Side of the Building is Located in the Lawn Area on the West Side of the Site		
<b>Pipes</b>				
—	Schedule 40 PVC	Mainline Pipe	Match Existing Line Size; Control Wiring Shall be Tucked Under Mainline for Protection; Schedule 80 Fittings Shall be Used for Mainline Components	6/L2.3
—	Schedule 40 PVC	Lateral Line Pipe	See Plan for Pipe Sizes; Pipes Unmarked Shall be 1 Inch; Minimum Pipe Size Shall be 1 Inch for PVC Pipe	6/L2.3
<b>Controller</b>				
A	Existing Controller Located in Basement of Building that Irrigates North Side of Building; Controller Shall be Adjusted for New Valves and Valves that Need to be Eliminated			
B	Existing Controller Located in Basement of Building that Irrigates South Side of Building; Controller Shall be Adjusted for New Valves and Valves that Need to be Eliminated			
<b>Sleeving</b>				
—	Schedule 40 PVC	Provide for Irr. Mainlines, Lateral, and Controller Wire Located under Concrete and Asphalt Paving at specified depths	Contractor shall Coordinate the Installation of Sleeving with the Installation of Concrete Paving and Asphalt Paving. All Sleeving is by the Landscape Contractor unless otherwise noted.	2/L2.3
		Valve Callout	Valve Number Valve Flow Valve Size	

#### VALVE SCHEDULE - North Side Irrigation System

VALVE STATION	VALVE SIZE	IRRIGATION TYPE	FLOW (GPM)	PSI	PRECIP RATE
A1	1"	Area for Drip Emitters	0.94	37.0	0.54 in/h

#### VALVE SCHEDULE - South Side Irrigation System

VALVE STATION	VALVE SIZE	IRRIGATION TYPE	FLOW (GPM)	PSI	PRECIP RATE
B1	1"	Area for Drip Emitters	2.56	37.3	0.63 in/h
B2	1"	Area for Drip Emitters	3.83	37.6	0.42 in/h

